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MUMBAI TRANS HARBOUR LINK PROJECT PACKAGE 4 - TENDER DRAWING

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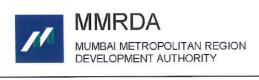
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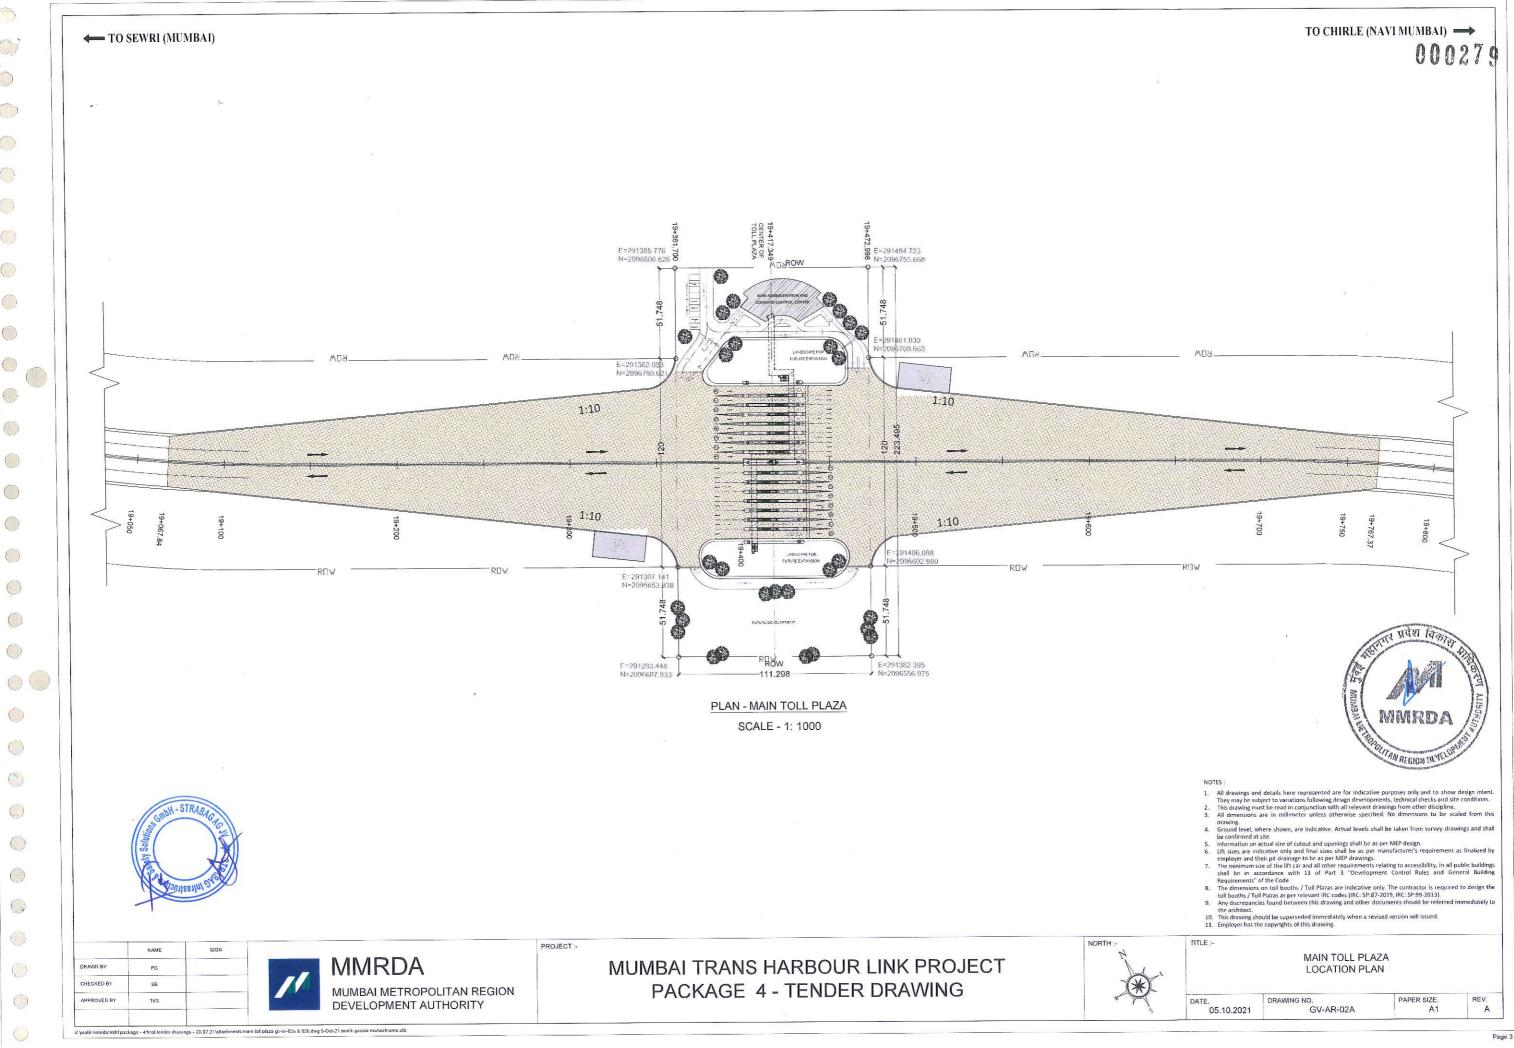
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MUMBAI TRANS HARBOUR LINK PROJECT PACKAGE 4 - TENDER DRAWING

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INDEX OF ATTACHMENTS

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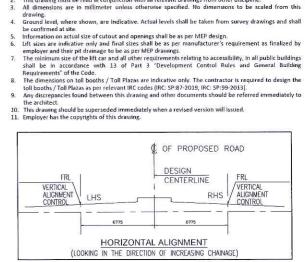
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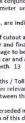
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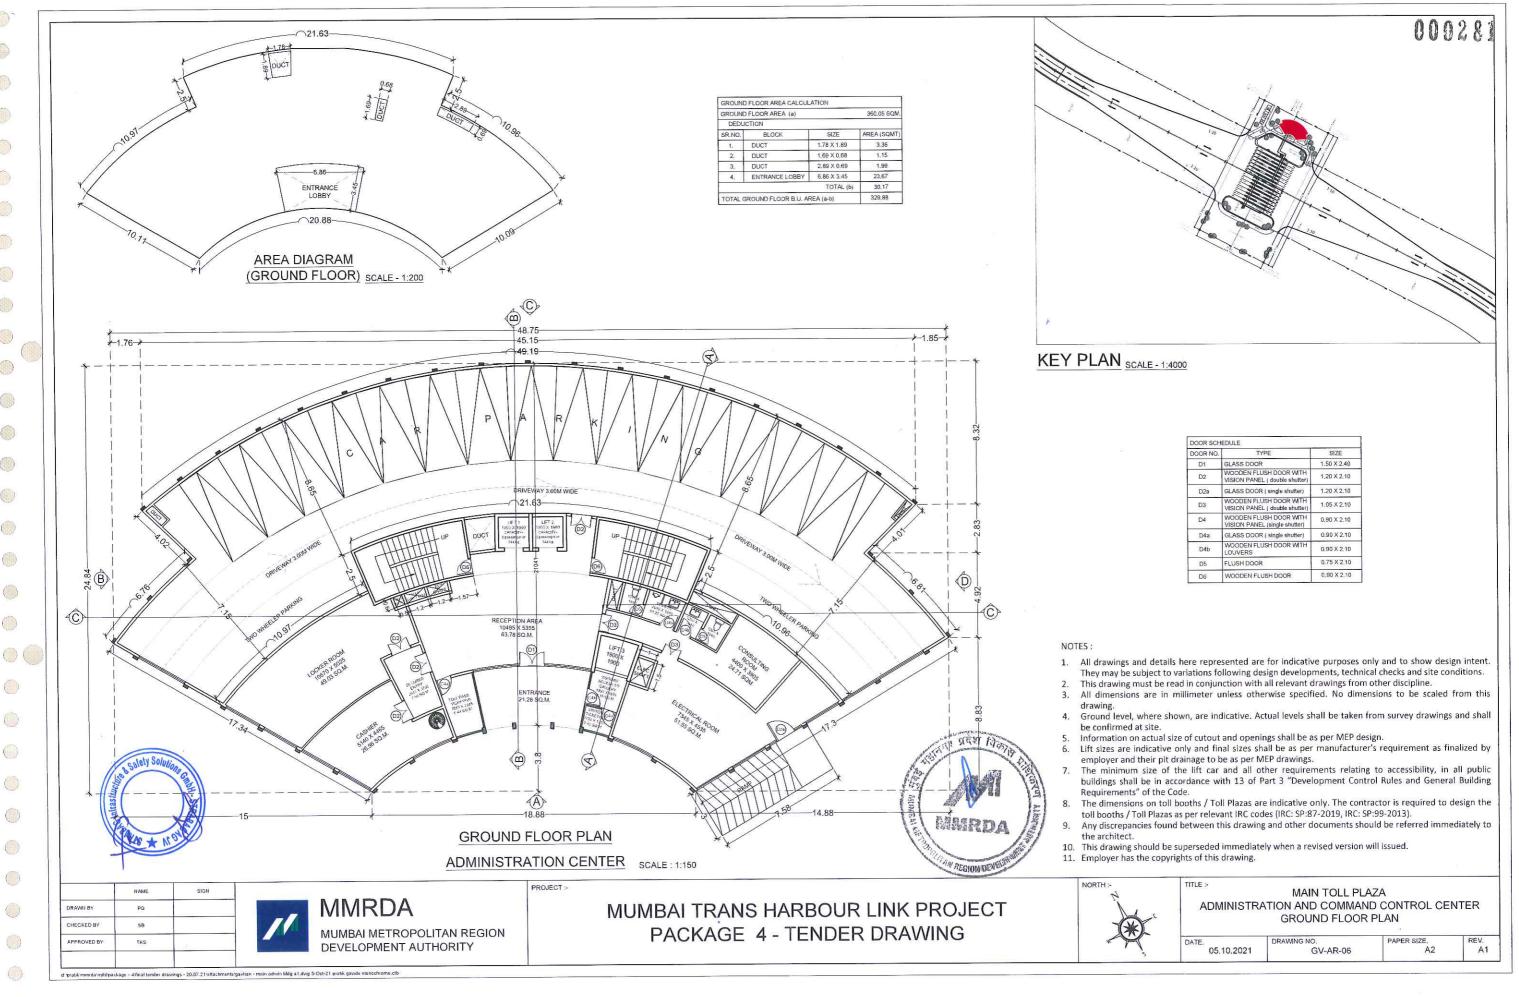









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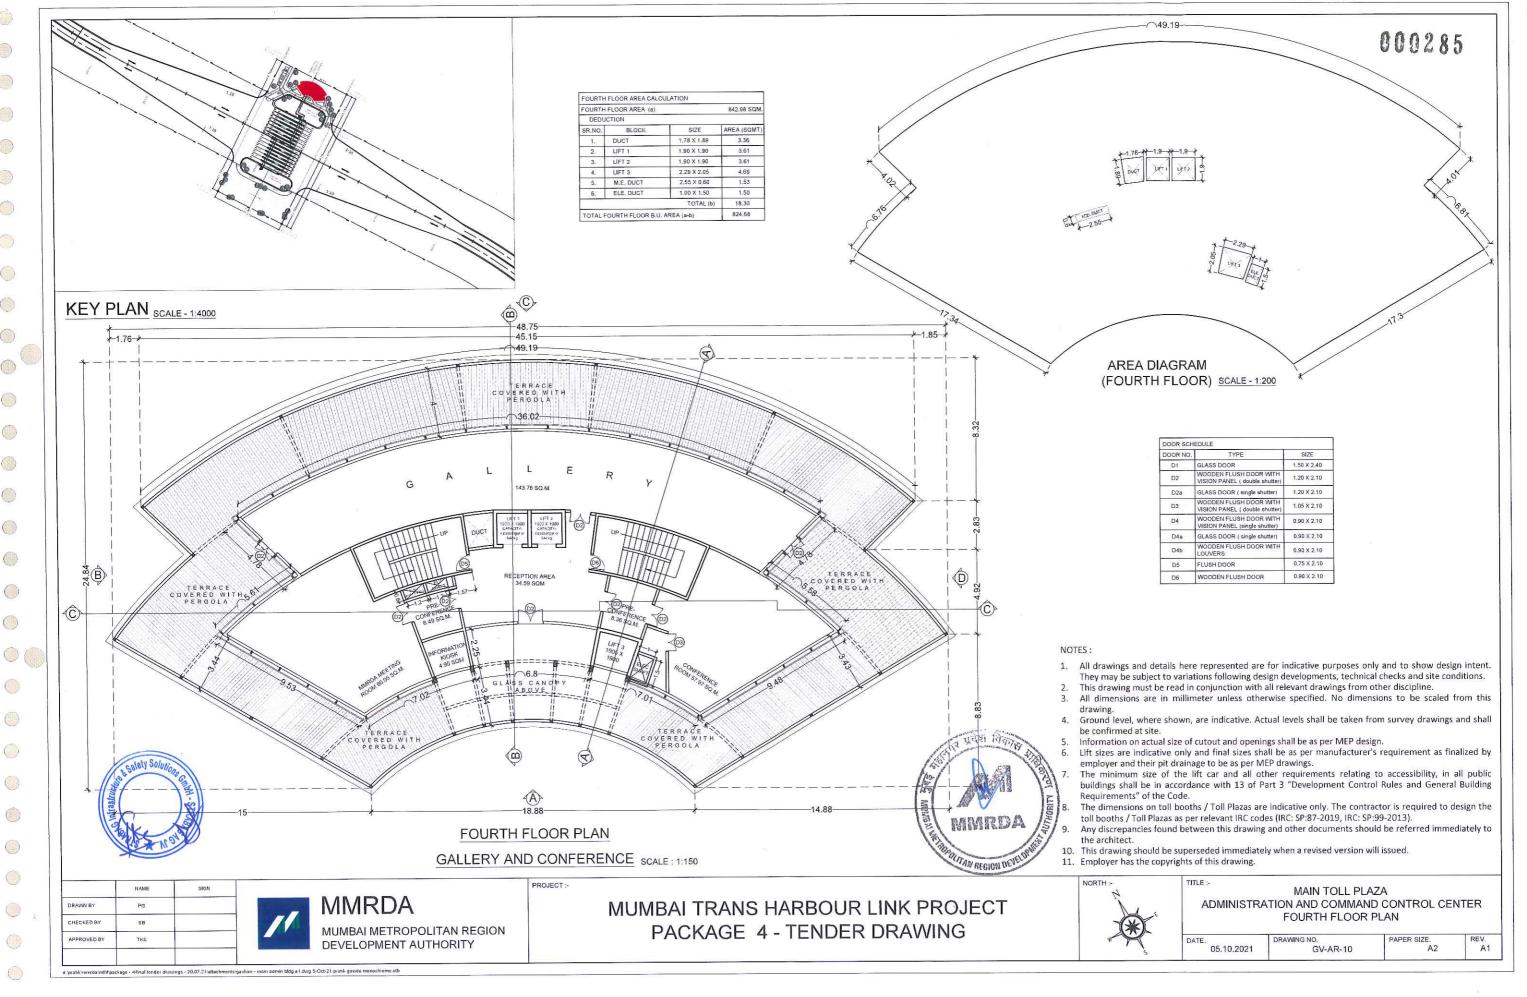


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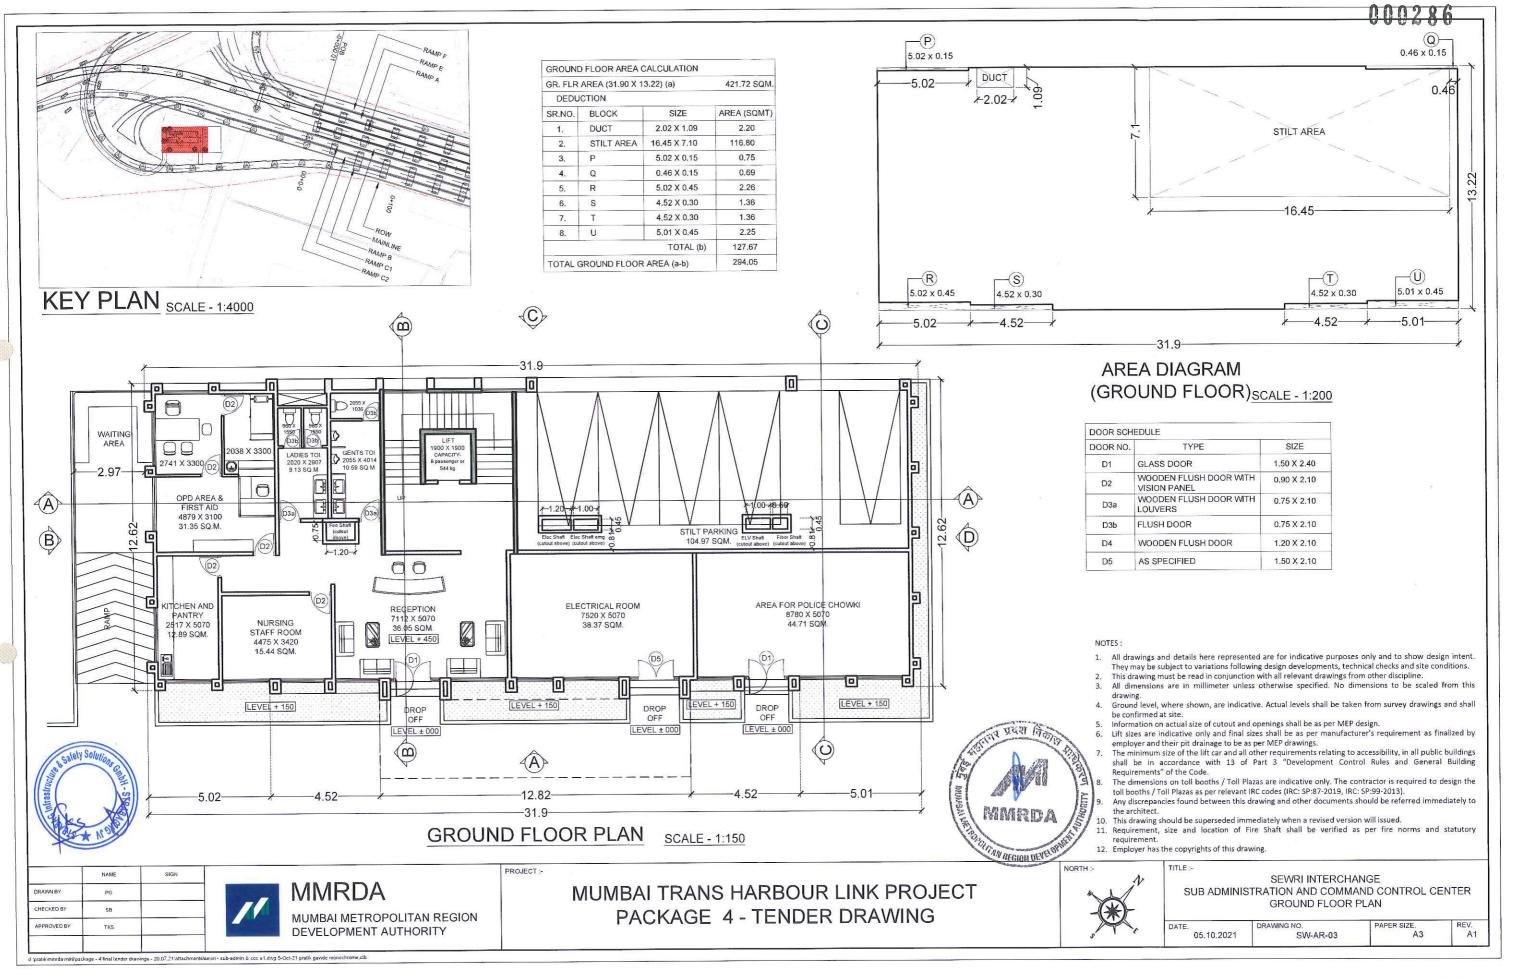
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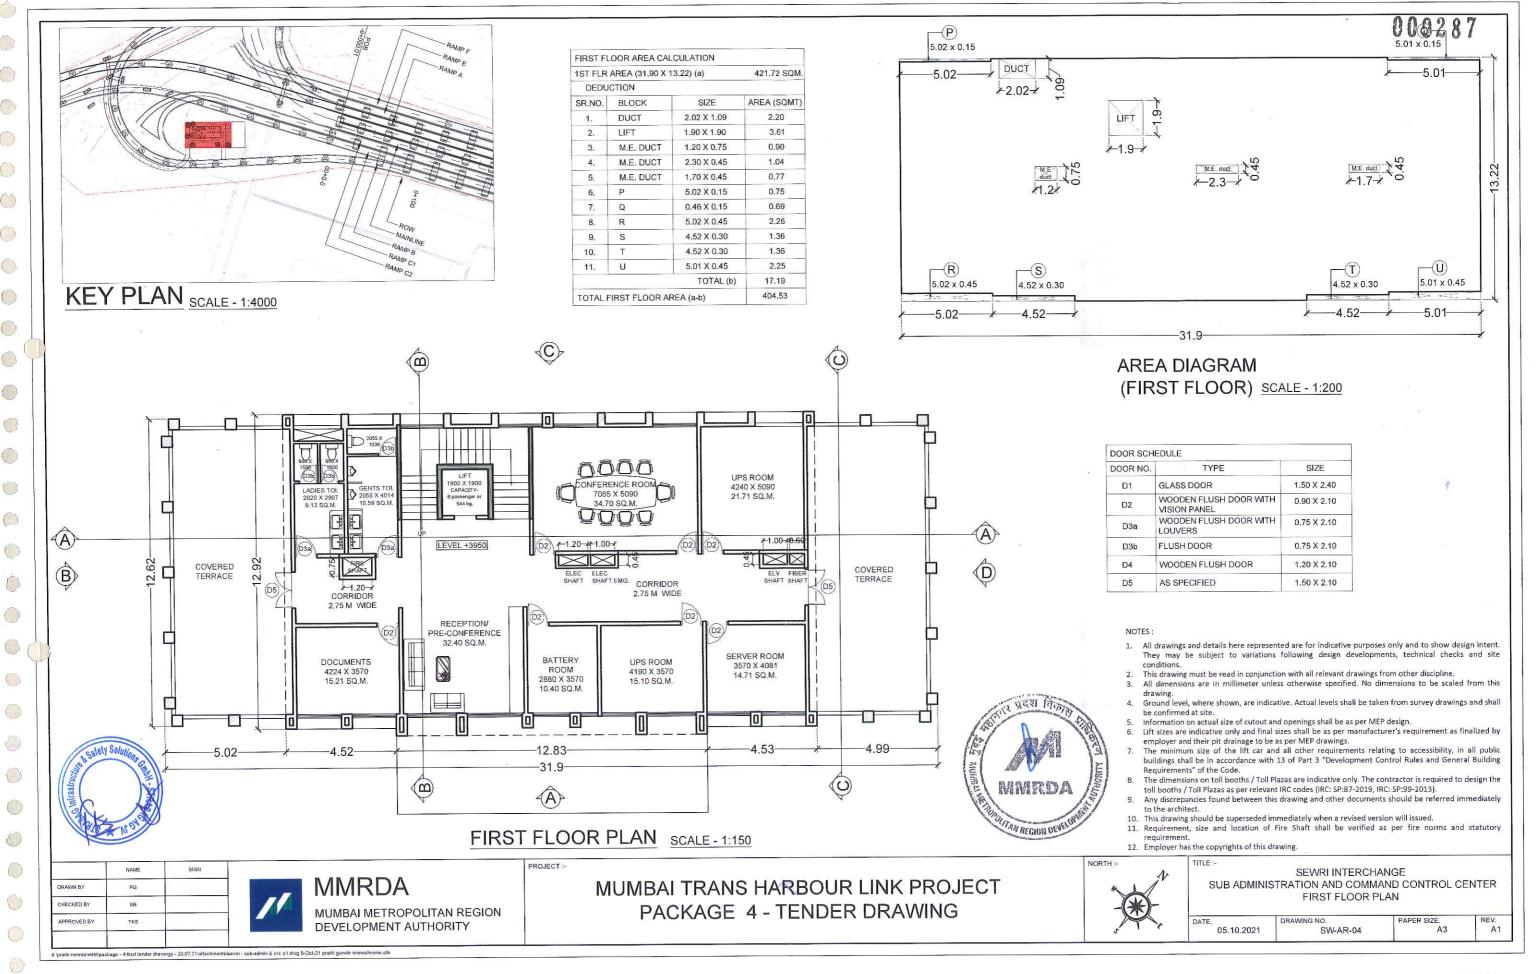
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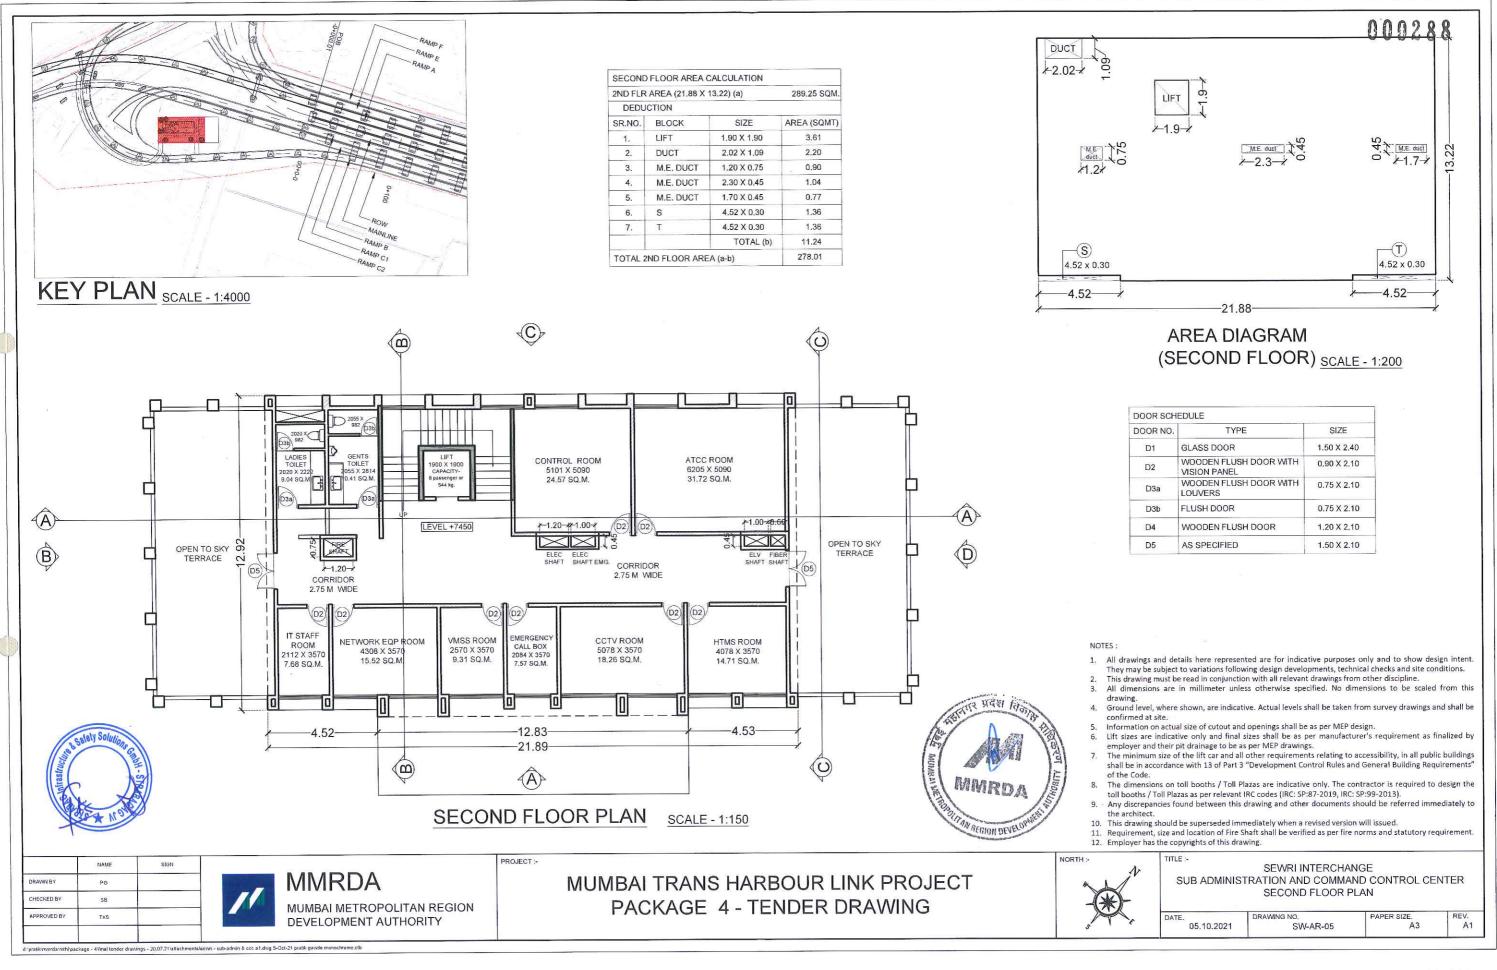



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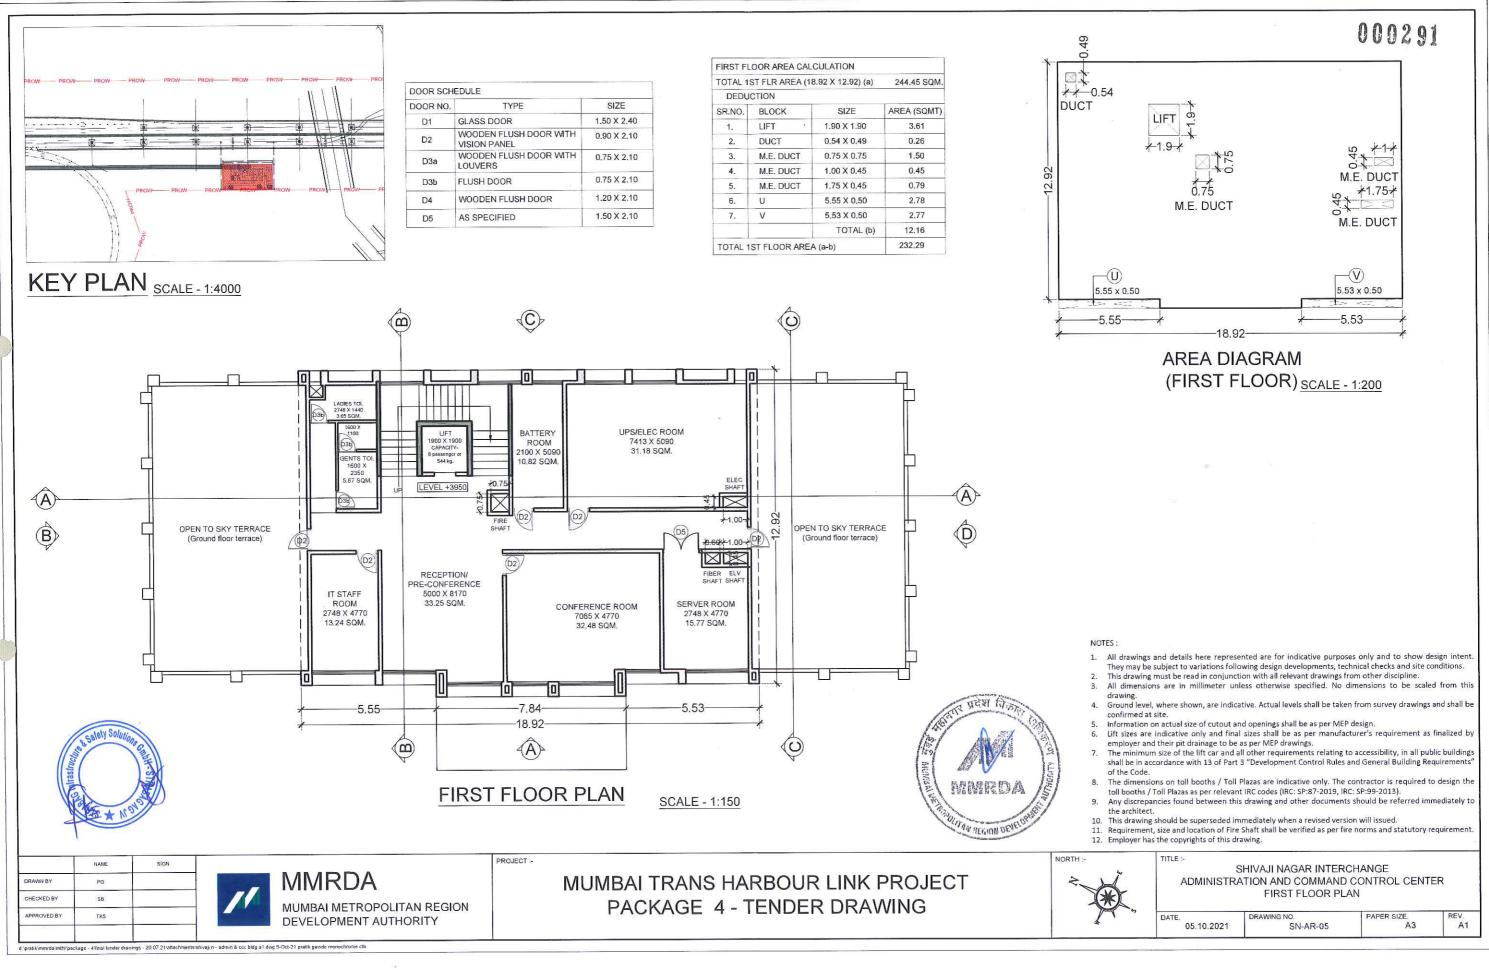
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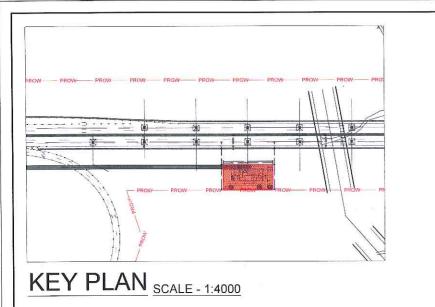

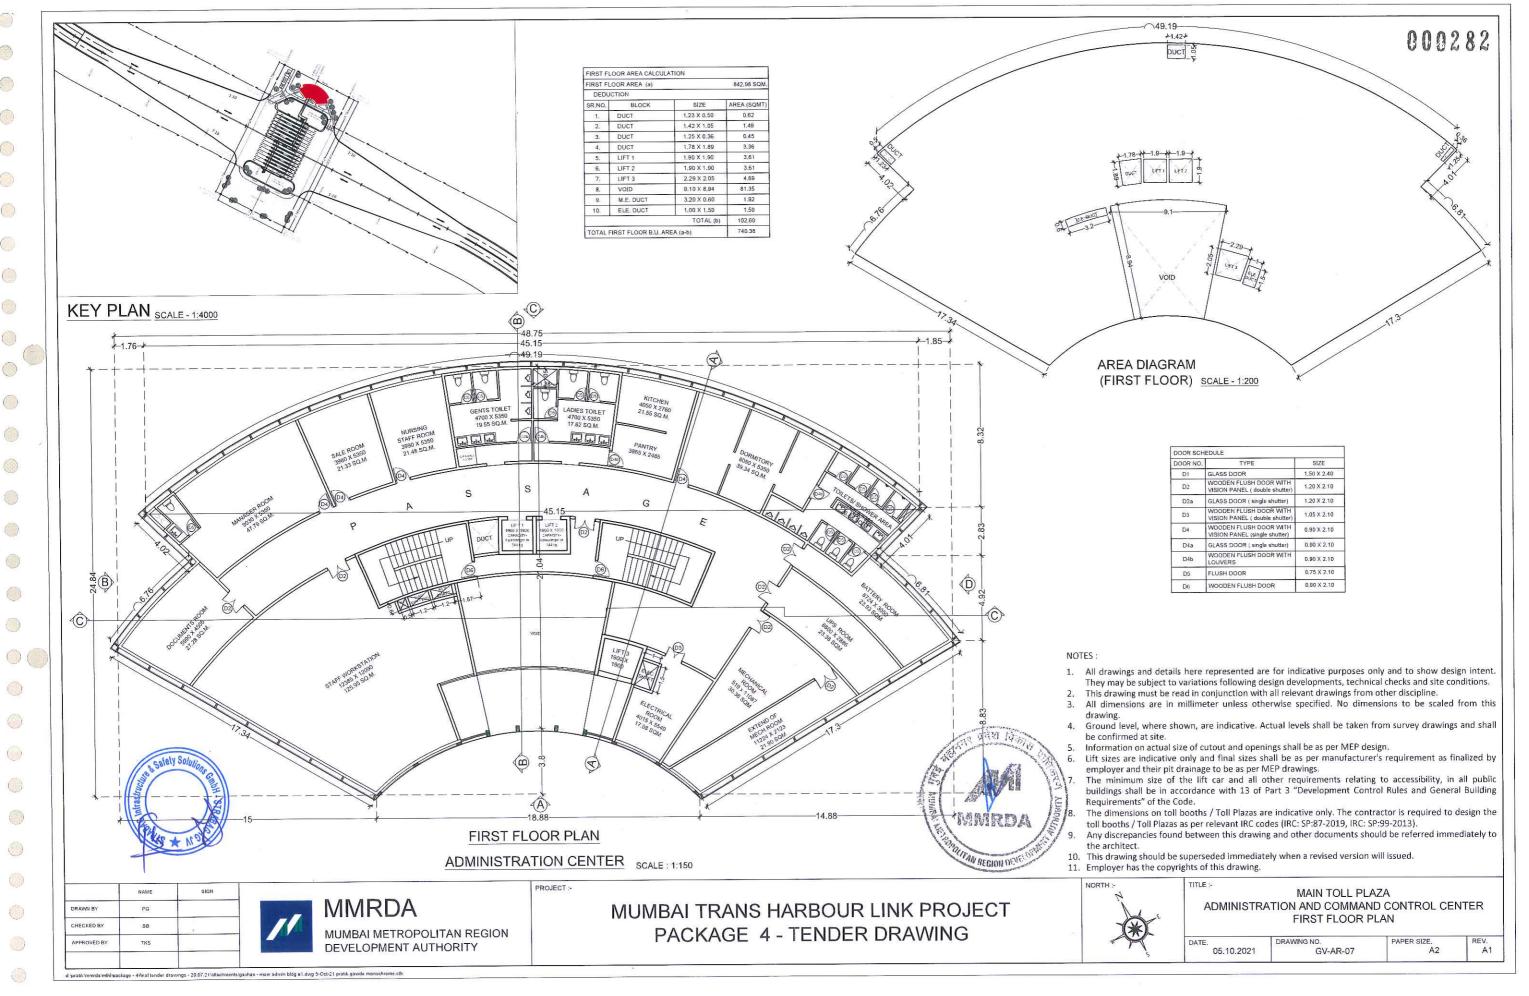
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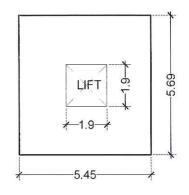
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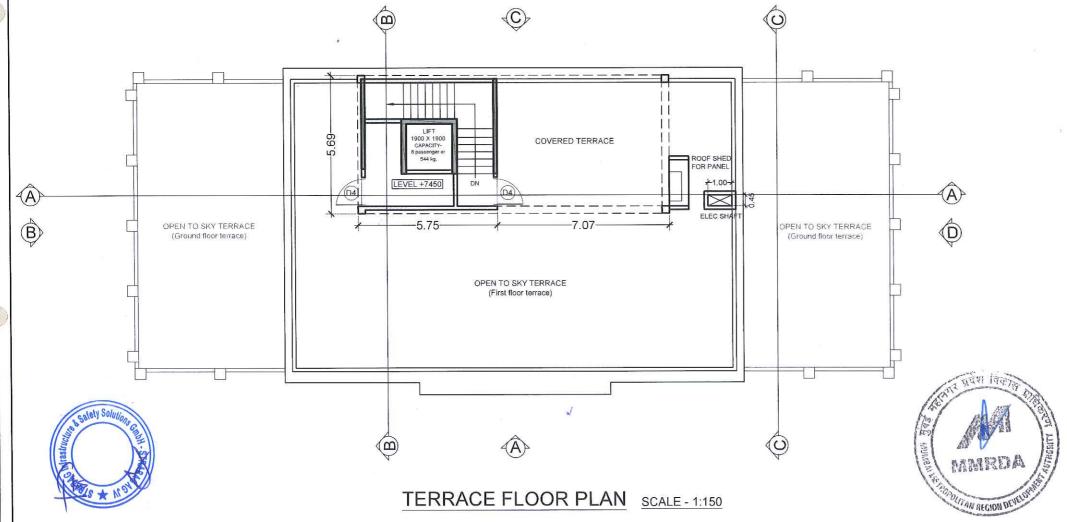
DOOR NO.	TYPE	SIZE	
D1	GLASS DOOR	1.50 X 2.40	
D2	WOODEN FLUSH DOOR WITH VISION PANEL	0.90 X 2.10	
D3a	WOODEN FLUSH DOOR WITH LOUVERS	0.75 X 2.10	
D3b	FLUSH DOOR	0.75 X 2.10	
D4	WOODEN FLUSH DOOR	1.20 X 2.10	
D5	AS SPECIFIED	1.50 X 2.10	

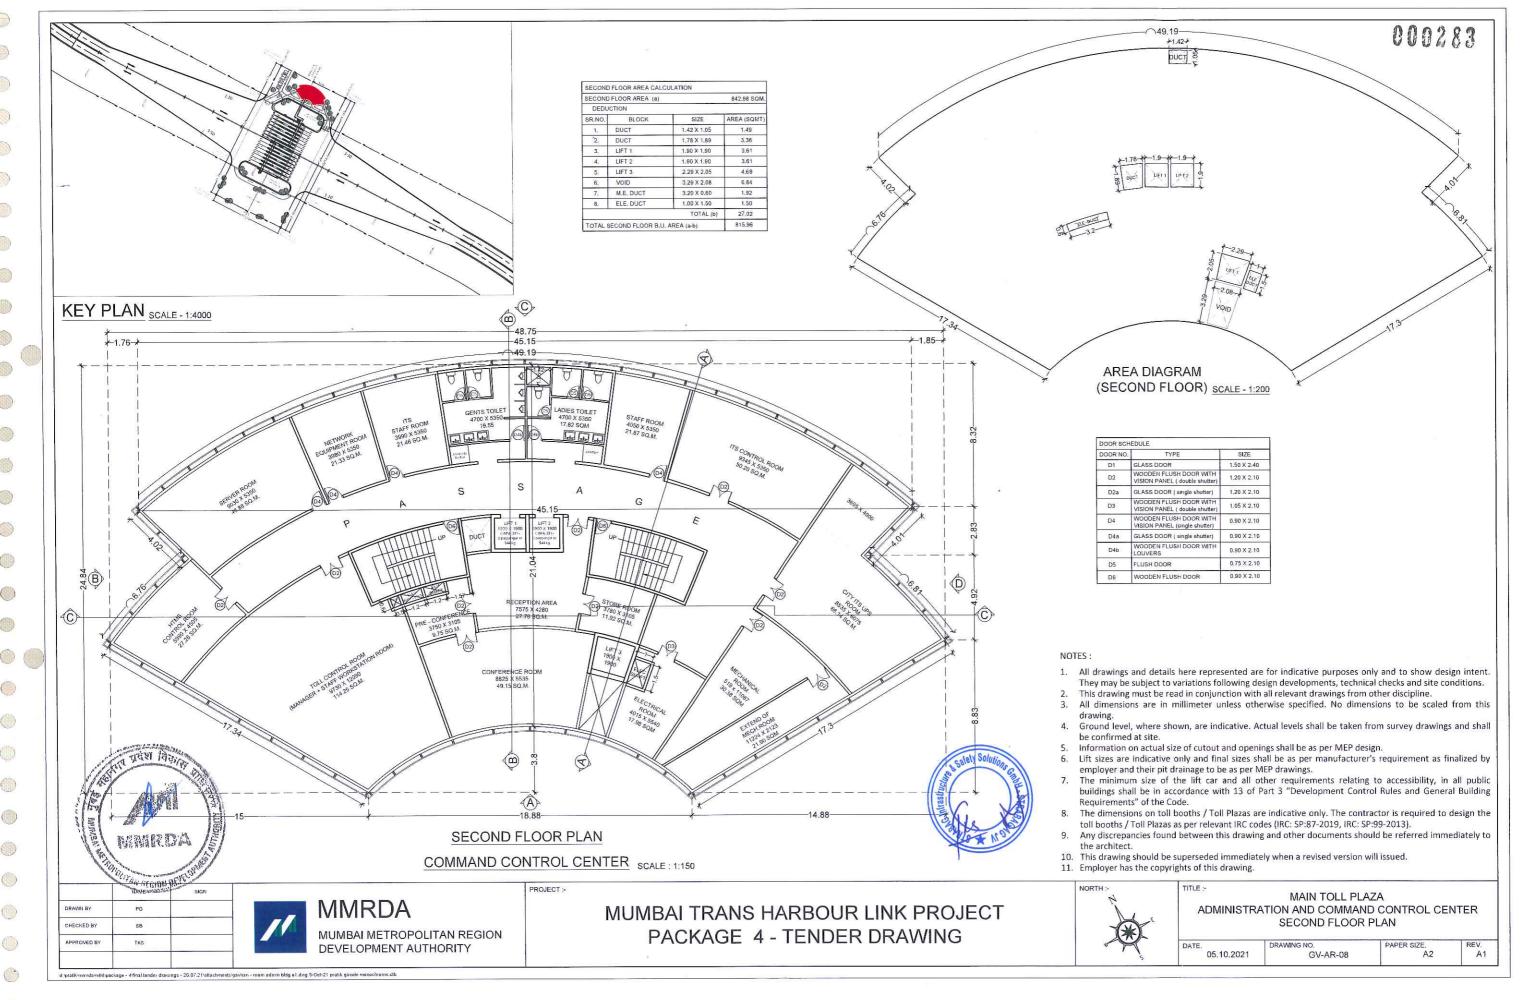TERRAC	E FLR AREA (5.45 X 5.69) (a)	31.01 SQM.
DEDU	CTION		·
SR.NO.	BLOCK	SIZE	AREA (SQMT)
1.	LIFT	1.90 X 1.90	3.61
		TOTAL (b)	3.61
TOTAL T	ERRACE FLO	OR AREA (a-b)	27.40

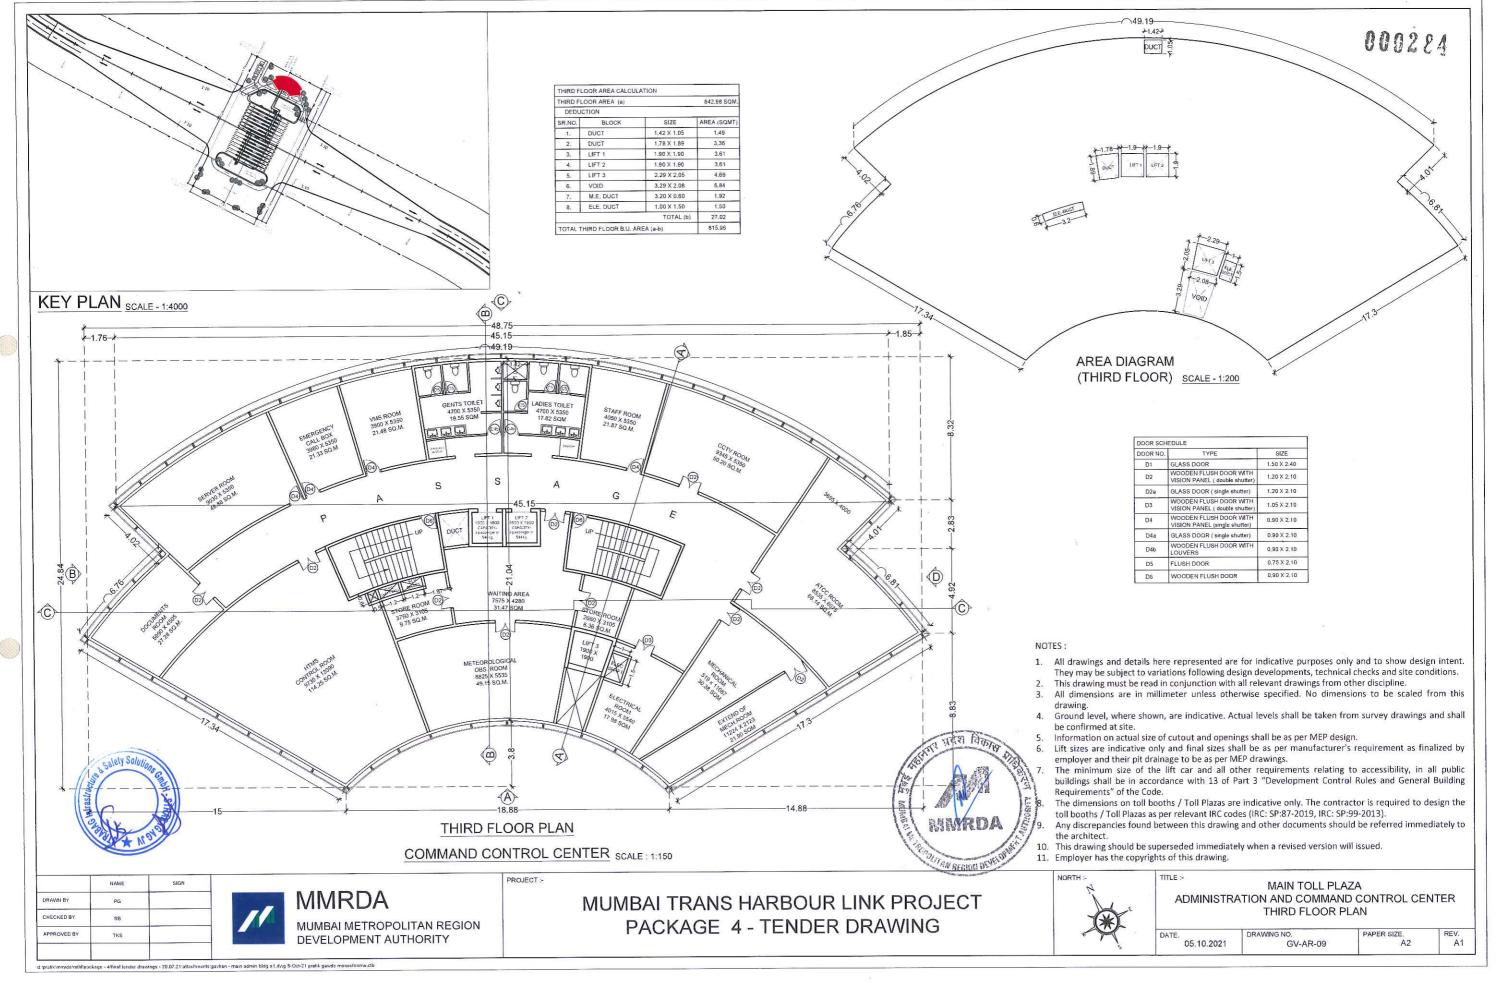

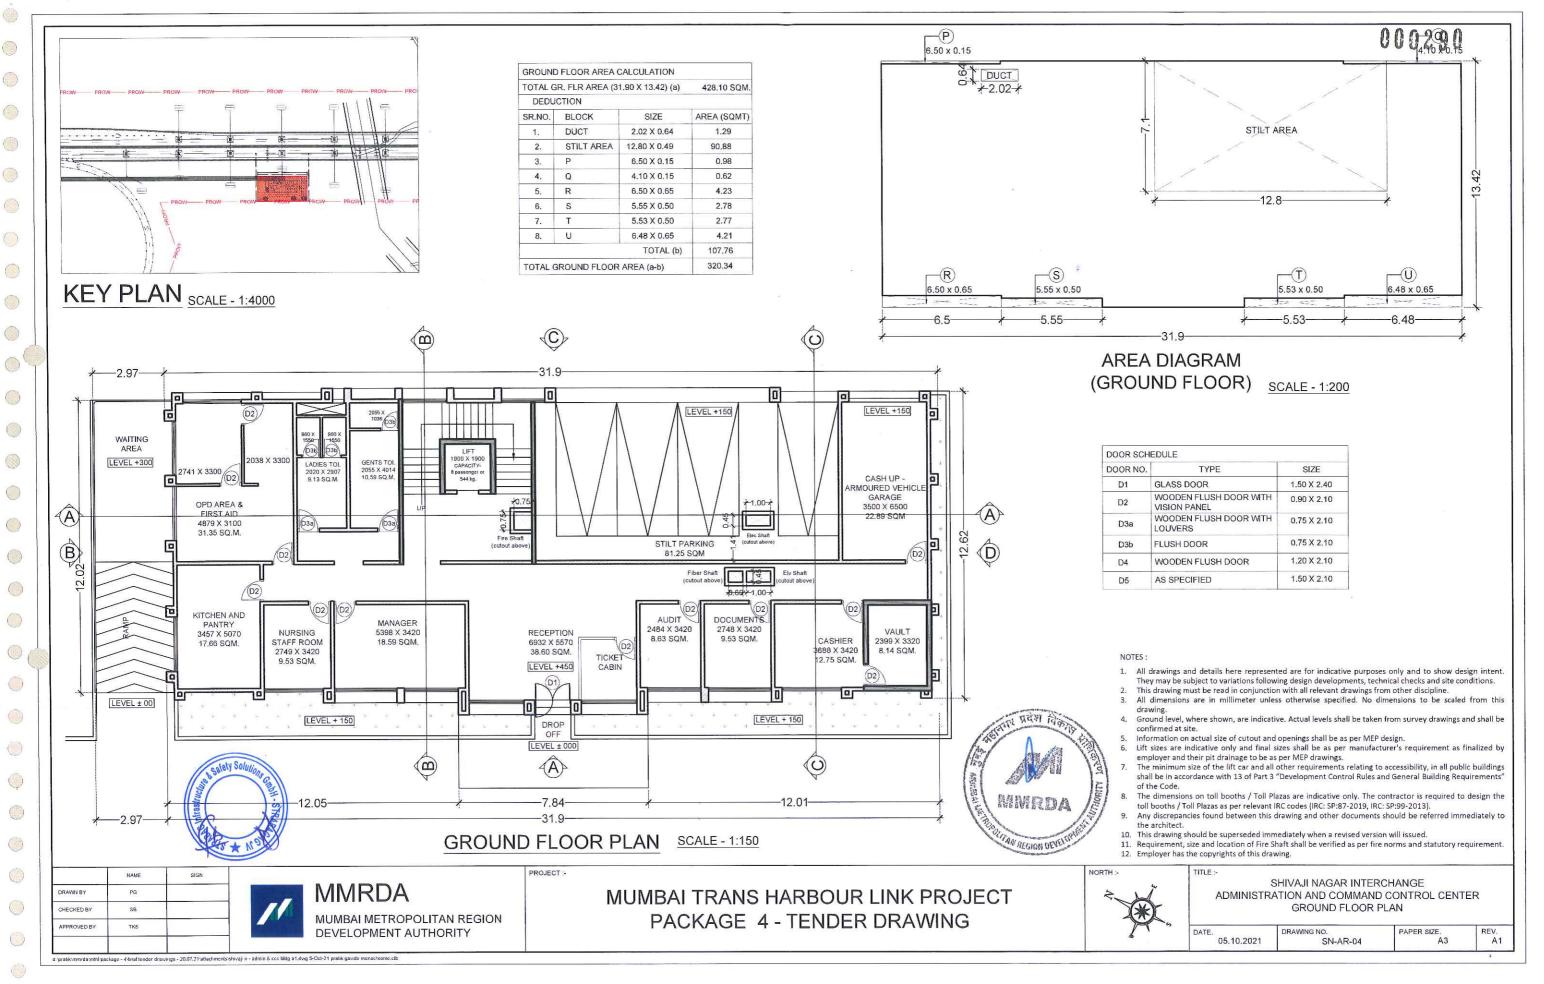

AREA DIAGRAM (TERRACE FLOOR) SCALE - 1:150



- 1. All drawings and details here represented are for indicative purposes only and to show design intent
- They may be subject to variations following design developments, technical checks and site conditions. This drawing must be read in conjunction with all relevant drawings from other discipline.
- All dimensions are in millimeter unless otherwise specified. No dimensions to be scaled from this
- Ground level, where shown, are indicative. Actual levels shall be taken from survey drawings and shall be confirmed at site.
- Information on actual size of cutout and openings shall be as per MEP design.
- Lift sizes are indicative only and final sizes shall be as per manufacturer's requirement as finalized by employer and their pit drainage to be as per MEP drawings.
- The minimum size of the lift car and all other requirements relating to accessibility, in all public buildings shall be in accordance with 13 of Part 3 "Development Control Rules and General Building Requirements"
- The dimensions on toll booths / Toll Plazas are indicative only. The contractor is required to design the toll booths / Toll Plazas as per relevant IRC codes (IRC: SP:87-2019, IRC: SP:99-2013).
- Any discrepancies found between this drawing and other documents should be referred im the architect.
- 10. This drawing should be superseded immediately when a revised version will issued.

 11. Requirement, size and location of Fire Shaft shall be verified as per fire norms and statutory requirement
- 12. Employer has the copyrights of this drawing.




SHIVAJI NAGAR INTERCHANGE ADMINISTRATION AND COMMAND CONTROL CENTER TERRACE FLOOR PLAN

REV. DRAWING NO. 05.10.2021

APPROVED BY

MMRDA MUMBAI METROPOLITAN REGION DEVELOPMENT AUTHORITY

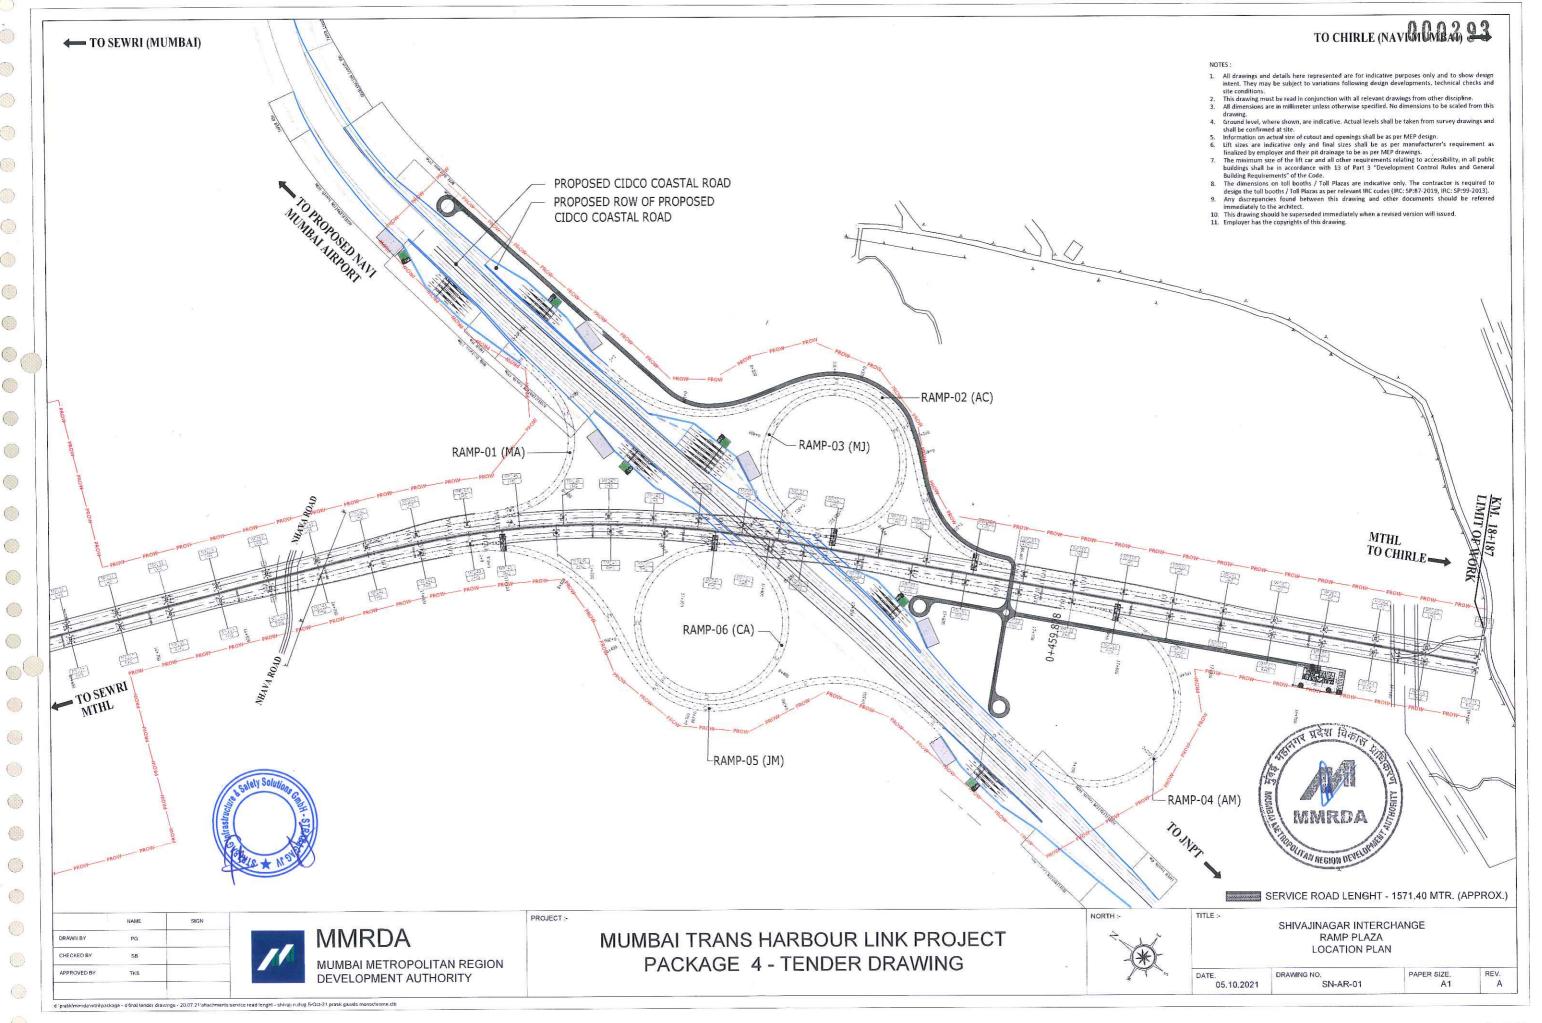

Addendum- 1 Attachment- 3

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DIMENSIONS	TOLERANCE	
0-10	+/- 0.1	
11-50	+/- 0.2	
51-100	+/- 0.3	
101-500	+/- 0.5	
501-1000	+/- 0.8	
1001-3000	+/- 1.2	
Above 3000	+/- 2.0	

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- 3) DIMENSIONS IN THE DRAWING ARE PROPOSED.
- 4) ALL CORNERS AND EDGES ARE REMOVED.


NOTE-

- ISLAND HEIGHT REQUIRED MINIMUM 150 mm TO MAXIMUM 610 mm.
- 2) REQUIRED CONCRETE IN LANE.

PROJECTION=

000294

THIRD ANGLE

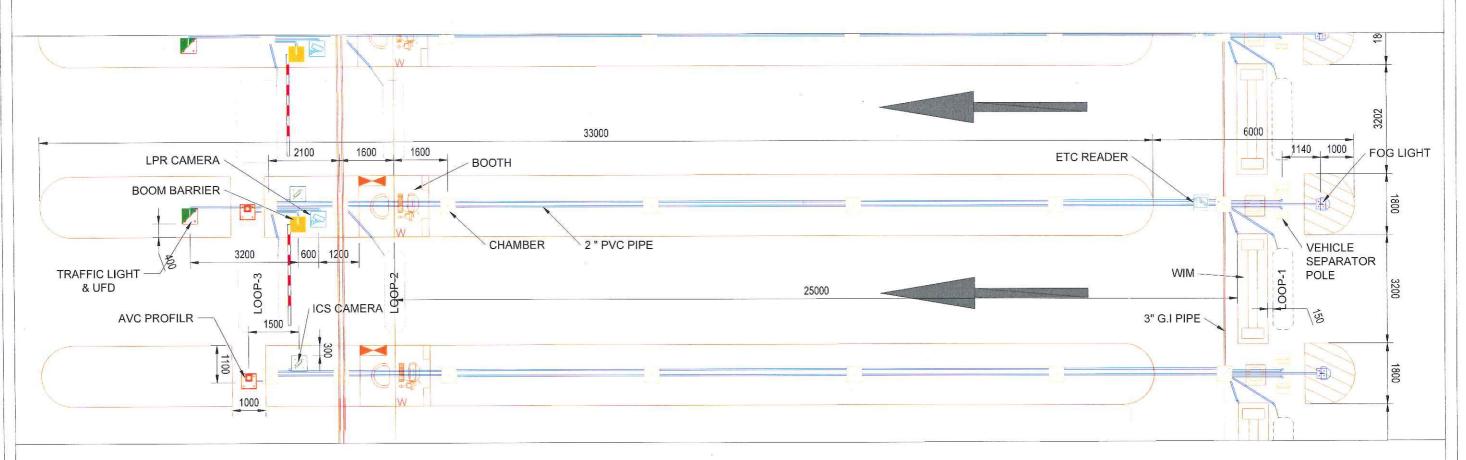

OTHER SIZES					
SR.NO.	DESCRIPTION	DESCRIPTION SIZE LxW (mm)			
Α	воотн	3200 x 1600			
В	LOOP - 1 & 2.	2400x900			
С	LOOP - 3	2400x1200			
D	2" PUC. PIPE	O.D =50			
E	3" G.I PIPE	O.D =76			
F	MS WIM				
G	CHAMBER	600x600x600			
Н	FOG LIGHT				



PROJECT :-



FOUNDATION SIZES					
SR.NO.	DESCRIPTION	SIZE HxWxD (mm)	SYMBOL	FOUNDATION BOLT PITCH (mm)	
1	ETC ANTENNA TOWER	460x460x600		240x240	
2	BOOM BARRIER	460x460x600		180x180	
3	AVC PROFILER	460x460x600		240x240	
4	CAMERA TOWER	460x460x600	0	240x240	
5	TRAFFIC LIGHT, UFD	460x460x600		240x240	
6.	VEHICLE SEPARATOR POLE	460x460x600	F-	240x240	
7	LMR CAMERA	460x460x600	5	240x240	

	NAME	SIGN
DRAWN BY		
CHECKED BY		
APPROVED BY		



MUMBAI TRANS HARBOUR LINK PROJECT PACKAGE 4 - TENDER DRAWING

NORTH:- STANDARD SINGLE LANE LAYOUT
WITH WIM

DATE. DRAWING NO. PAPER SIZE. REV. O6.10.2021 P4-ITC-004 A1 01

Page 18 of 25

Addendum- 1 Attachmer

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GENERAL TOLERANCES **TOLERANCE DIMENSIONS** +/- 0.1 0-10 11-50 +/- 0.2 51-100 +/- 0.3 101-500 +/- 0.5 501-1000 +/- 0.8 +/- 1.2 1001-3000 Above 3000 +/- 2.0

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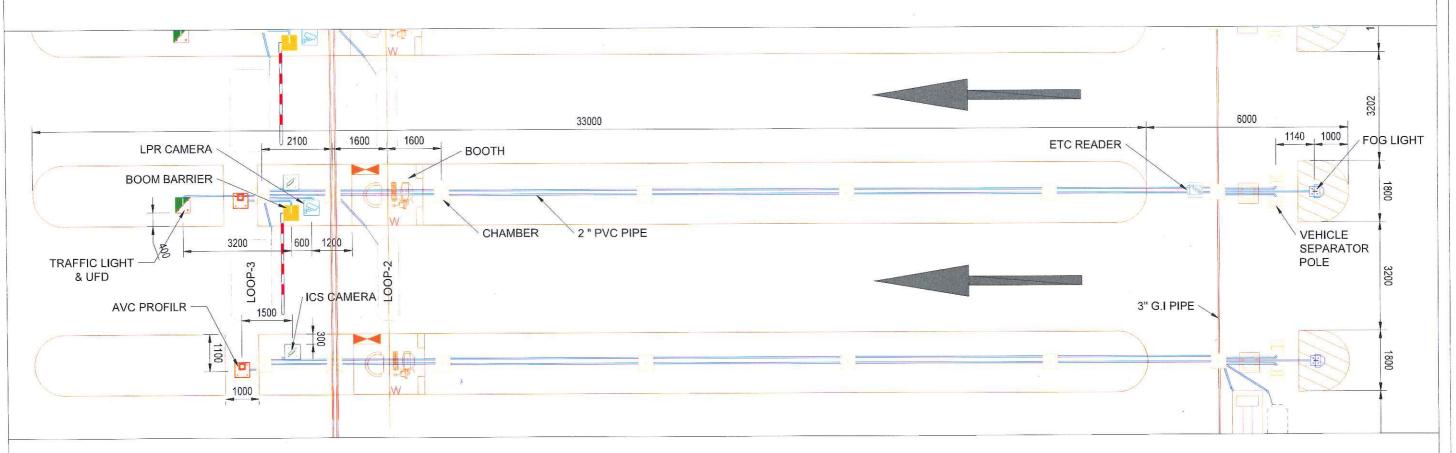
NOTE-

- 1) ISLAND HEIGHT REQUIRED MINIMUM 150 mm TO MAXIMUM 610 mm.
- 2) REQUIRED CONCRETE IN LANE.

PROJECTION=

000285

THIRD ANGLE



	OT	HER SIZES	
SR.NO.	DESCRIPTION	SIZE LxW (mm)	SYMBOL
Α	воотн	3200 × 1600	
В	LOOP - 1 & 2.	2400×900	
С	LOOP - 3	2400x1200	
D	2" PUC. PIPE	O,D =50	
Е	3" G.I PIPE	O.D =76	
F	MS WIM		
G	CHAMBER	600x600x600	
Н	FOG LIGHT		



PROJECT :-



	FC	DUNDATION S	SIZES	
SR.NO.	DESCRIPTION	SIZE HxWxD (mm)	SYMBOL	FOUNDATION BOLT PITCH (mm)
1	ETC ANTENNA TOWER	460x460x600	y july	240x240
2	BOOM BARRIER	460x460x600		180x180
3	AVC PROFILER	460x460x600		240x240
4	CAMERA TOWER	460x460x600	0	240x240
5	TRAFFIC LIGHT, UFD	460x460x600		240x240
6	VEHICLE SEPARATOR POLE	460x460x600	F-	240x240
7	LPR CAMERA	460x460x600		240x240

MANUE	SIGN
NAME	ajan
	NAME



MUMBAI TRANS HARBOUR LINK PROJECT PACKAGE 4 - TENDER DRAWING

NORTH:- TITLE:-

STANDARD SINGLE LANE LAYOUT WITH WIM

DATE. DRAWING NO. PAPER SIZE. REV. 06.10.2021 P4-ITC-004A A1 01

Page 19 of 25

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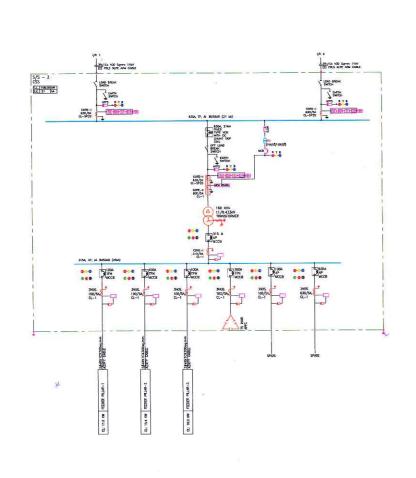
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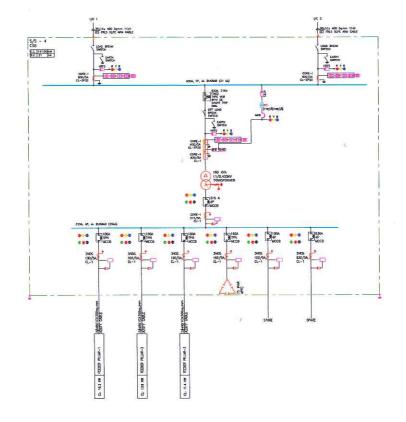
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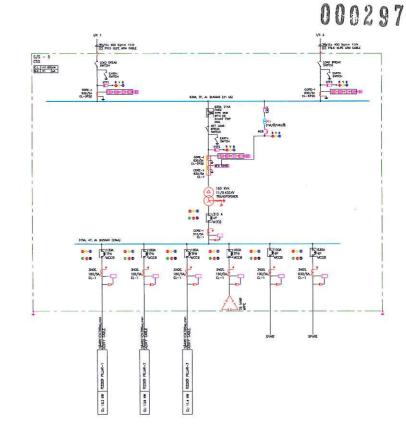
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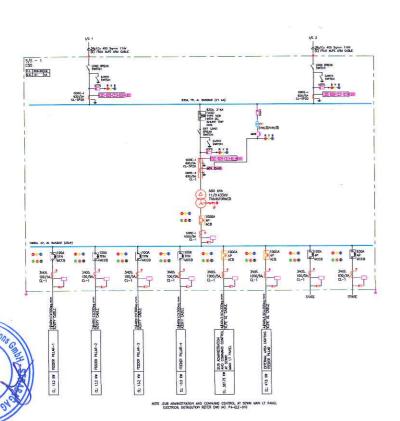
06.10.2021


P4 - ELE - 007









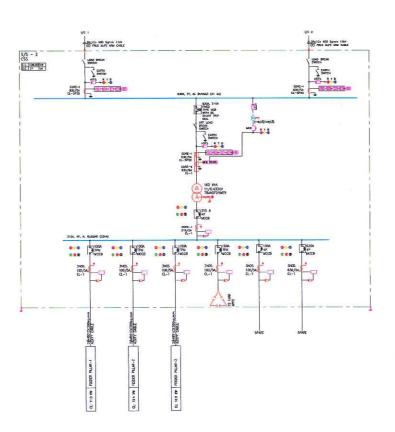

STARGET A POLE A

SAMOU	DESCRIPTION .
5	4 POLE AIR CIRCUIT BREAKER
3	TPN MOULDED CASE CIRCUIT BREAKER (MCI
5	DP MCB
5	ELCB-EARTH LEAKAGE CRICUIT BREAKER
0	ATS-AUTOMATIC TRANSFER SWITCH
800	INDICATING LAMPS (RED. YELLOW & BLUE)
888	INDICATING LAWPS (ON, OFF & TRIP)
3	CT - CURRENT TRANSFORMER
•	HRC-LINK-TYPE-FUSE
DOL	DIRECT ONLINE STARTER (DOL)
4	EARTHING
KWH	KILOWATT HOUR METER
EEN	ELECTRONIC ENERGY METER
•	VOLTMETER
2	VOLTMETER-SELECTION SWITCH
B	AMULTER
1/2	STAR DELTA STARTER
[2]	INVERTOR
110m	D.G. SET
8-	TRANSFORMER
(**	404 TPN CONNECTOR IN ELEC. SHAFT

NOTES

TAN REGION DEVE

 All dimensions are in mm and are indicative. The dimensions are to be read and not scaled or measured from the drawings.

- 2. This drawing is indicative and meant for the purposes of illustration and reference. Further detailed design, sizing, routing, selection of material of construction (MOC), supply, laying, testing and commissioning complete shall be in accordance to appropriate Indian Standards and codes as defined and in coordination with Civil and Architectural designs, employer's requirements and further site specific detailing shall be completed in a detailed engineering manner by the design and built contractor for site specific use and operability. This includes coordination with all other design guides, specifications, standards, package 1, 2 & 3 civil work interface and provisions.
- and any relevant regulatory / statutory approval requirements.

 3. Drawings have been optimized for color printing. This drawing shall not be referred for Structural details.
- Structural details.

 4. The Submission of Detailed drawings shall however not relieve Package 4 Design and Build Contractor of any Design & Built obligations as and shall be responsible for desired and appropriate functionality, operability, quantity etc;

NAME SIGN

DRAWN BY PG

CHECKED BY SA

APPROVED BY AD

rda/mthl/package - 4/final tender drawings - 20.97.21 attachments sld dwgs p4-ele-008 r1.dwg 5-Oct-21 pratik gawde acad.ctb

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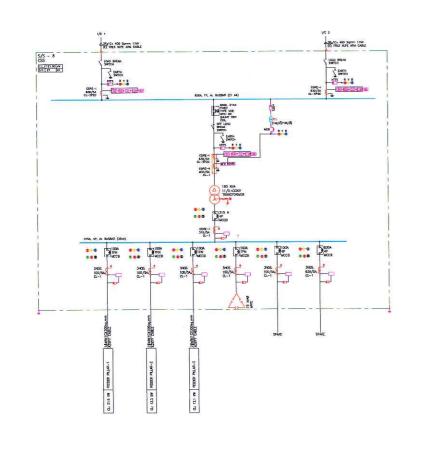



MUMBAI TRANS HARBOUR LINK PROJECT PACKAGE 4 - TENDER DRAWING


ELECTRICAL DISTRIBUTION OF SUB STATION NOS. 1 TO 5


DRAWING NO. P4 - ELE - 008 (1 OF 4) PAPER SIZE. REV. 01

Page 21 of 25



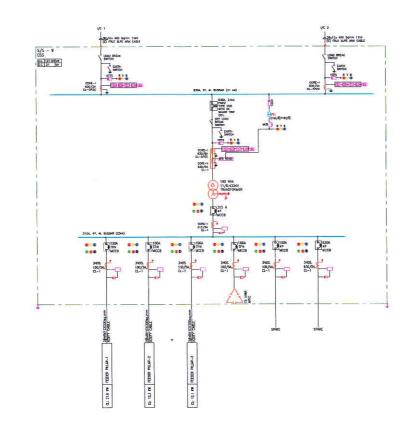

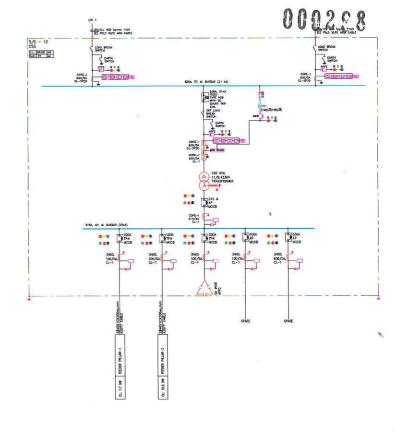

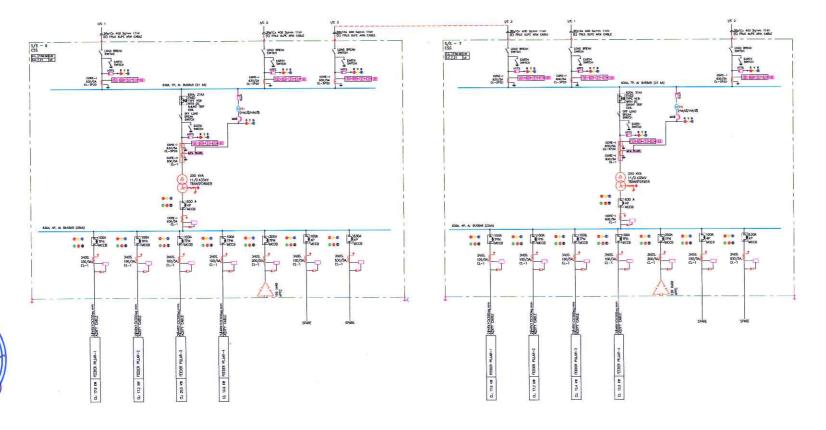

PROJECT :-



LEGENDS:

SYMBOL	DESCRIPTION
100	4 POLE AIR CIRCUIT BREAKER
5	TPN MOULDED CASE CIRCUIT BREAKER (MC
5	DP MCB
5	ELCB-EARTH LEAKAGE CIRCUIT BREAKER
Ø	ATS-AUTOMATIC TRANSFER SWITCH
444	INDICATING LAMPS (RED. YELLOW & BLUE)
387	INDICATING LAWPS (ON, OFF & TRIP)
3	CT - CURRENT TRANSFORMER
40	HRC-LINK-TYPE-FUSE
DOL	DIRECT ONLINE STARTER (DOL)
1	EARTHING
60054	KILOWATT HOUR METER
EEE	ELECTRONIC ENERGY WETER
19	VOLTMETER
10	VOLTMETER-SELECTOR SWITCH
•	AUMETER
1/2	STAR DELTA STARTER
(Z)	INVERTOR
200	D.O. SET
8-	TRANSFORMER
CT.	40A TPN CONNECTOR IN ELEC SHAFT

 All dimensions are in mm and are indicative. The dimensions are to be read and not scaled or measured from the drawings.

- Scaled of measured more tradewings.

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	NAME	SIGN
DRAWN BY	PG	
CHECKED BY	SA	
APPROVED BY	AD	



MUMBAI TRANS HARBOUR LINK PROJECT PACKAGE 4 - TENDER DRAWING

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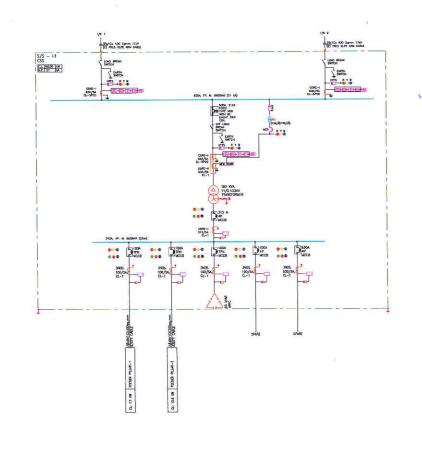
ELECTRICAL DISTRIBUTION OF SUB STATION NOS. 6 TO 9 & 12


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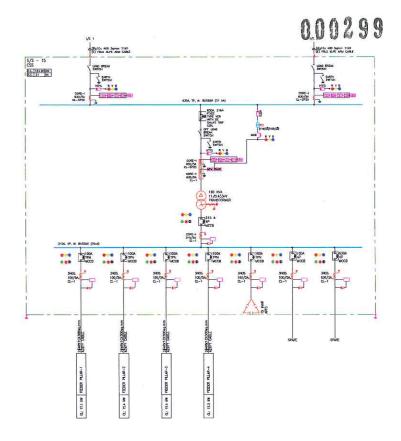
DRAWING NO. P4 - ELE - 008 (2 OF 4) PAPER SIZE. REV. 01


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Page 22 of 25







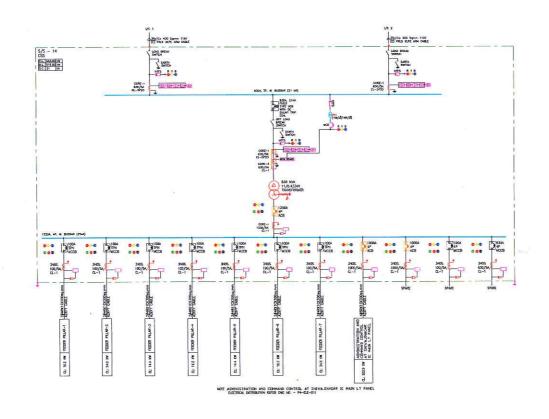

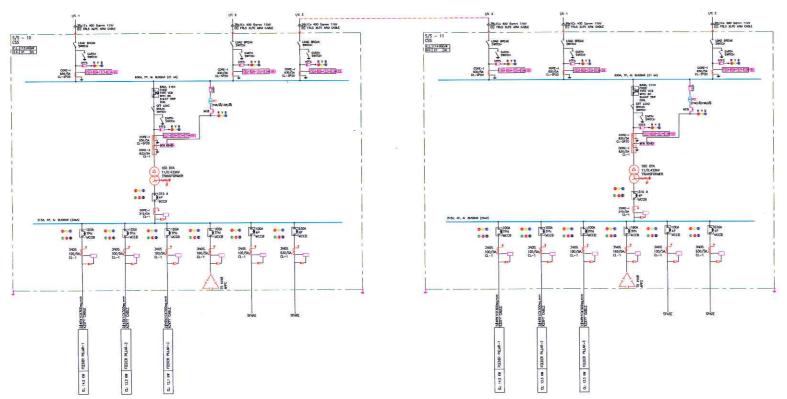PROJECT :-



4 FOLK AS CREATE BEAMER (ACC)

THE HOLING CASE CREATE BEAMER (ACC)

D PA (6)

AST-AUTHOR CASE CREATE BEAMER (ACC)

AST-AUTHOR TRANSPORTER BEAMER

AST-AUTHOR TRANSPORTER

E CT — CURBONT TRANSPORTER

E CT — CURBONT TRANSPORTER

COUNTY TRANSPORT

COUNTY TRANSPORTER

COUNTY TRANSPORTER

COUNTY TRANSPORTER

CO

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AN REGION DEVE

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MUMBAI TRANS HARBOUR LINK PROJECT PACKAGE 4 - TENDER DRAWING


ELECTRICAL DISTRIBUTION OF SUB STATION NOS. 10,11 & 13 TO 15


DATE. 05.10.2021 DRAWING NO. P4 - ELE - 008 (3 OF 4) PAPER SIZE. REV. 01

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LEGENDS :





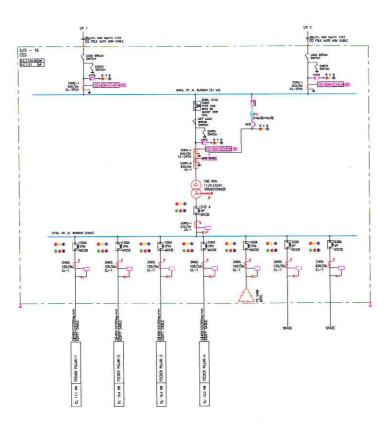

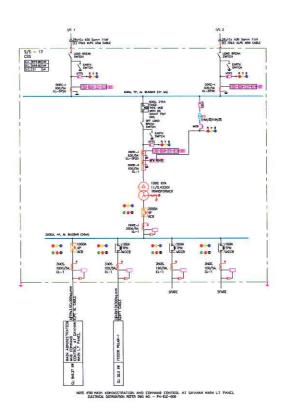



MMRDA MUMBAI METROPOLITAN REGION AD DEVELOPMENT AUTHORITY

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MWRDA

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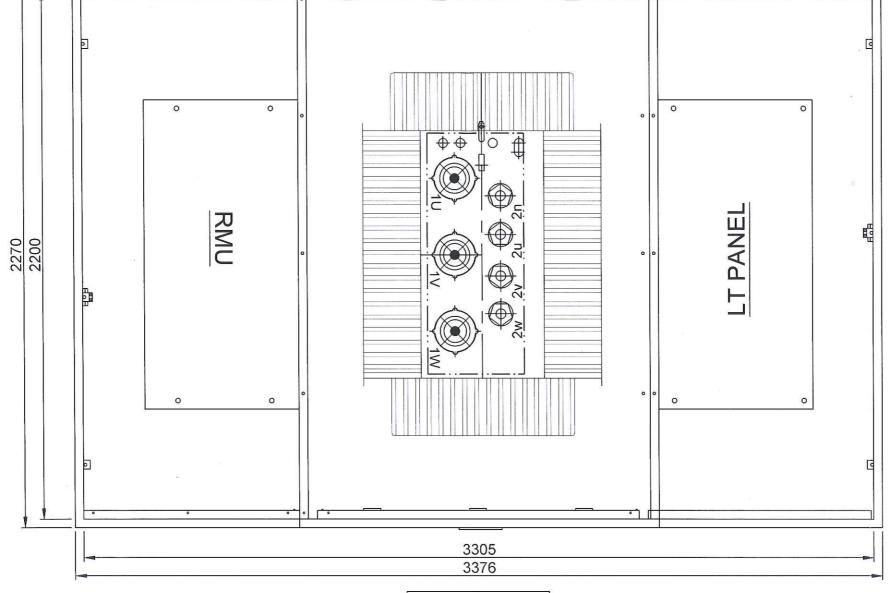
ELECTRICAL DISTRIBUTION OF SUB

STATION NOS. 16 & 17

DRAWING NO. P4 - ELE - 008 (4 OF 4)

REV. 01





SIDE-1



SIDE-4



ALL DIMENSION ARE IN MM UNLESS OTHERWISE SPECIFIED. DIMENSION TOLERANCE ± 5 %.

SIDE-3




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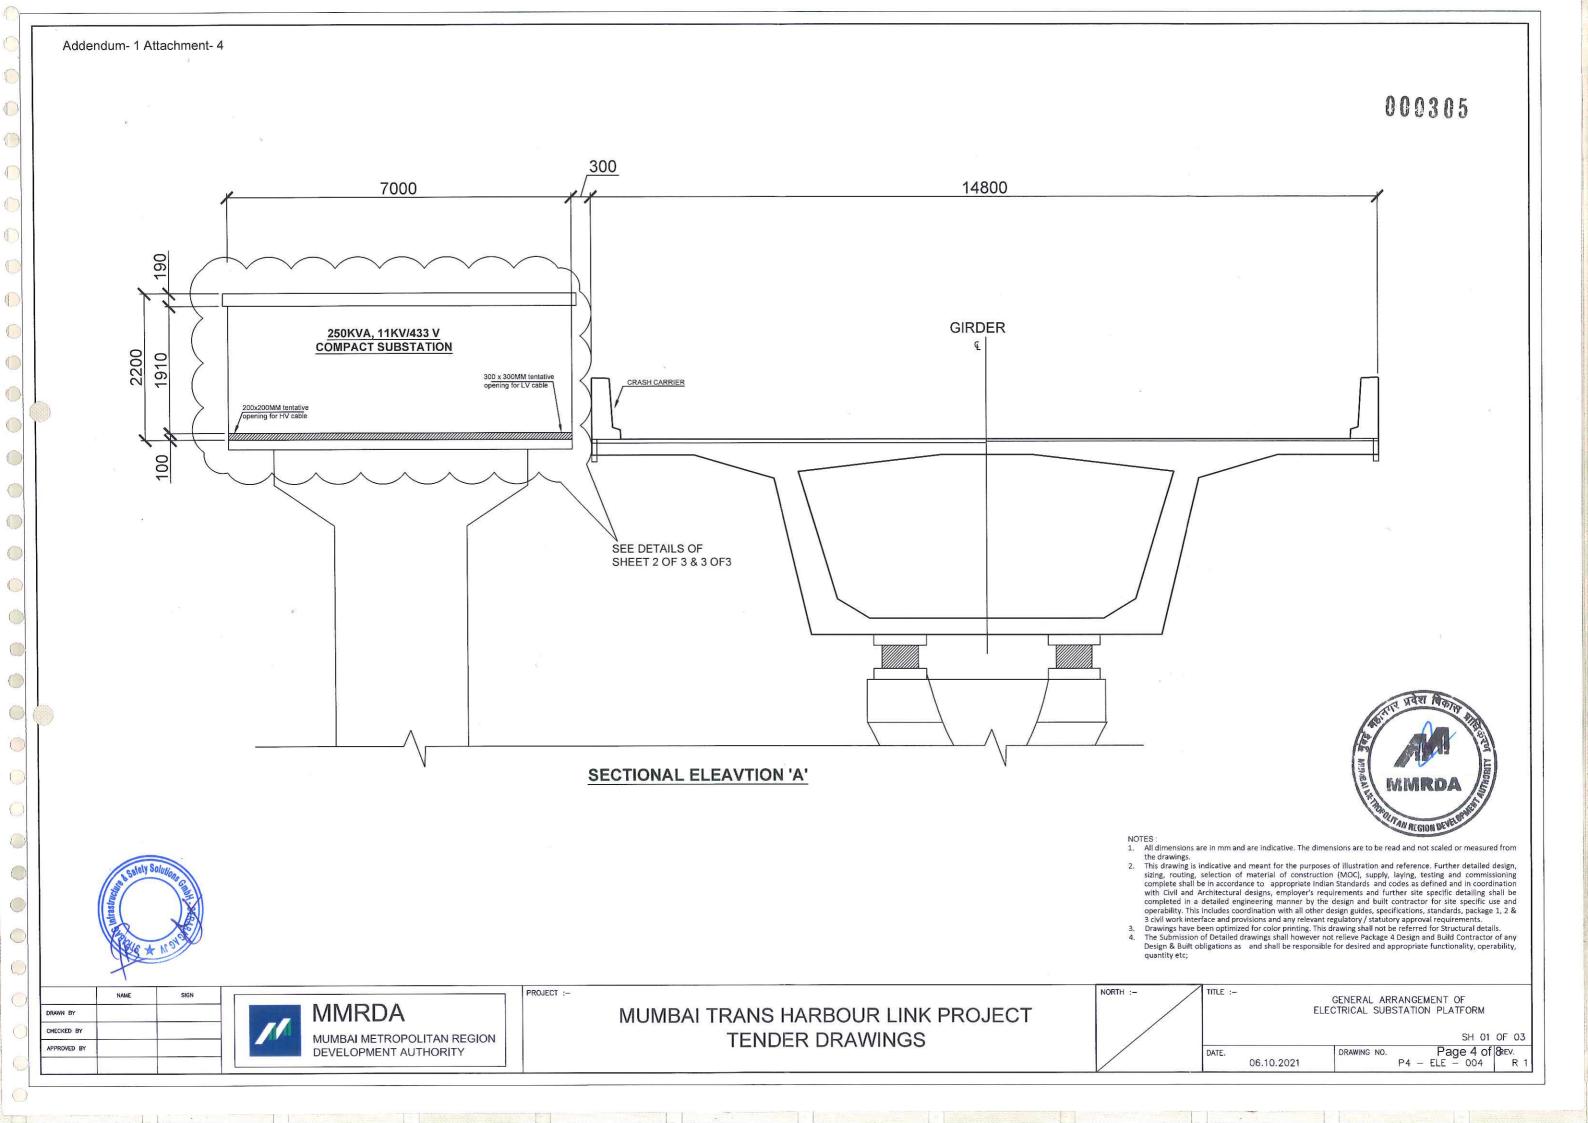



PROJECT :-


MUMBAI TRANS HARBOUR LINK PROJECT **TENDER DRAWINGS**

- /	IIILE :-	GENERAL ARRANGEMENT OF ELECTRICAL SUBSTATION PLATFORM				
			SH 02 OF 0			
	DATE. 06.10.2021	DRAWING NO.	Page 2 of & R - ELE - 004 R			



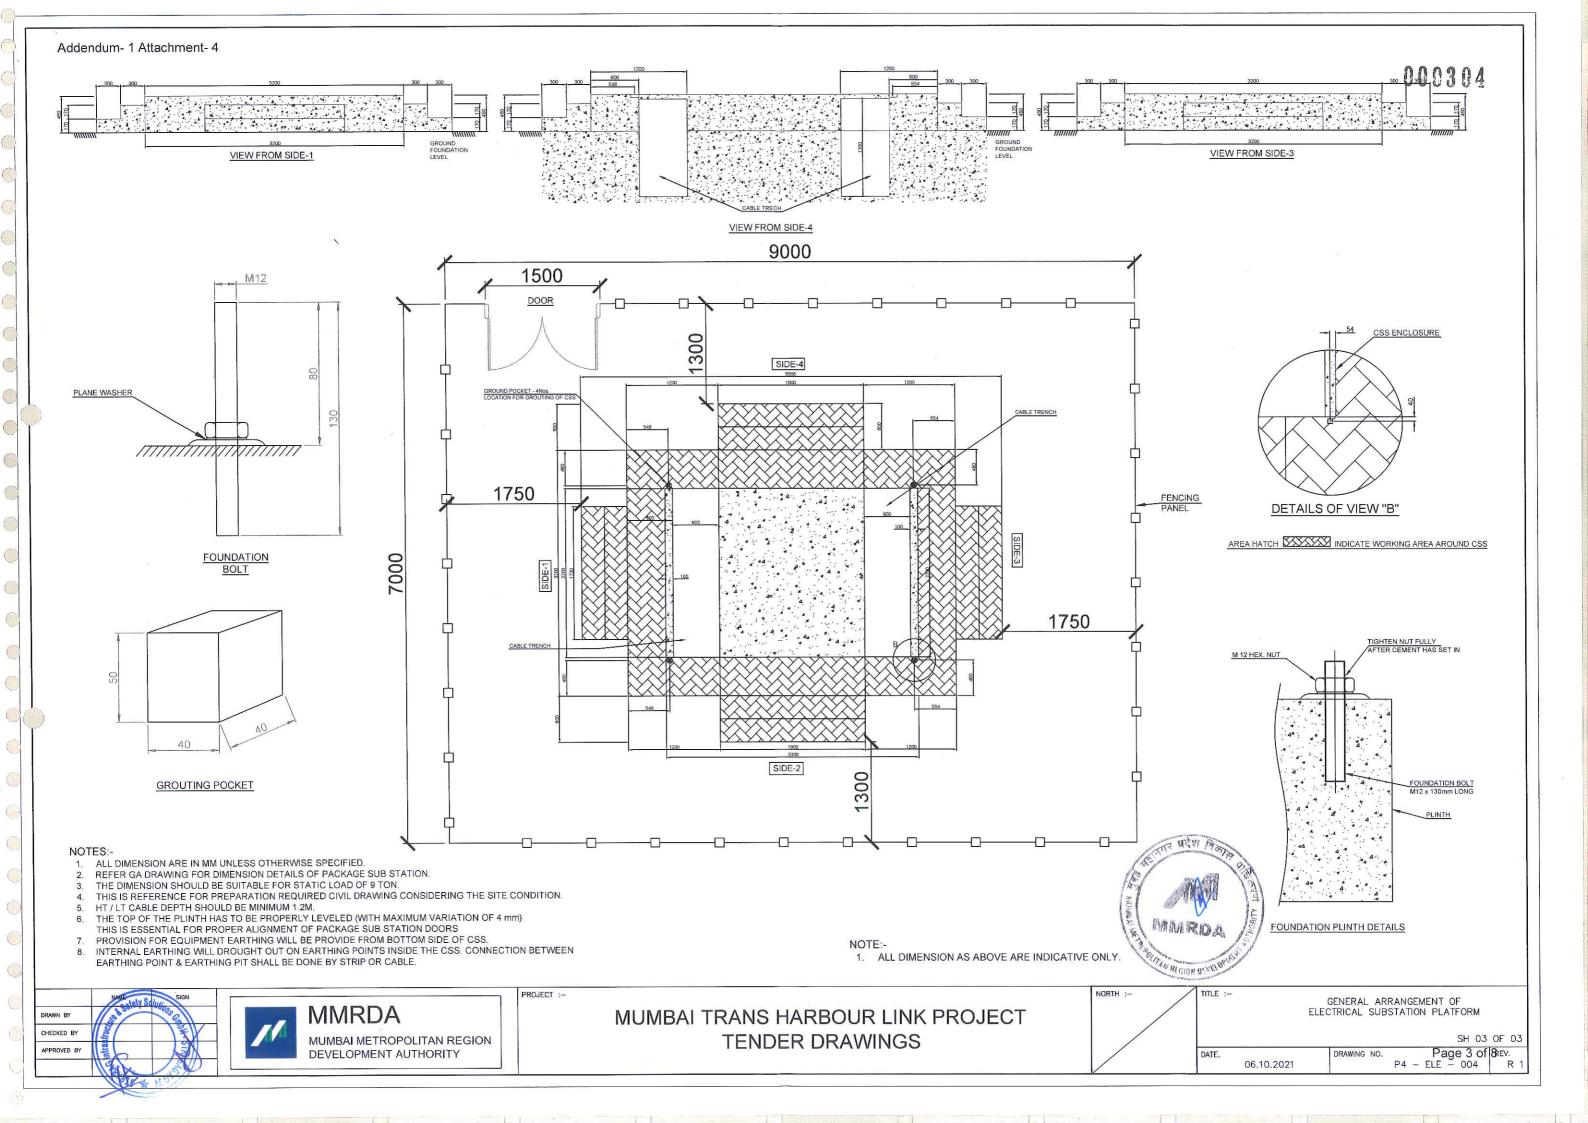

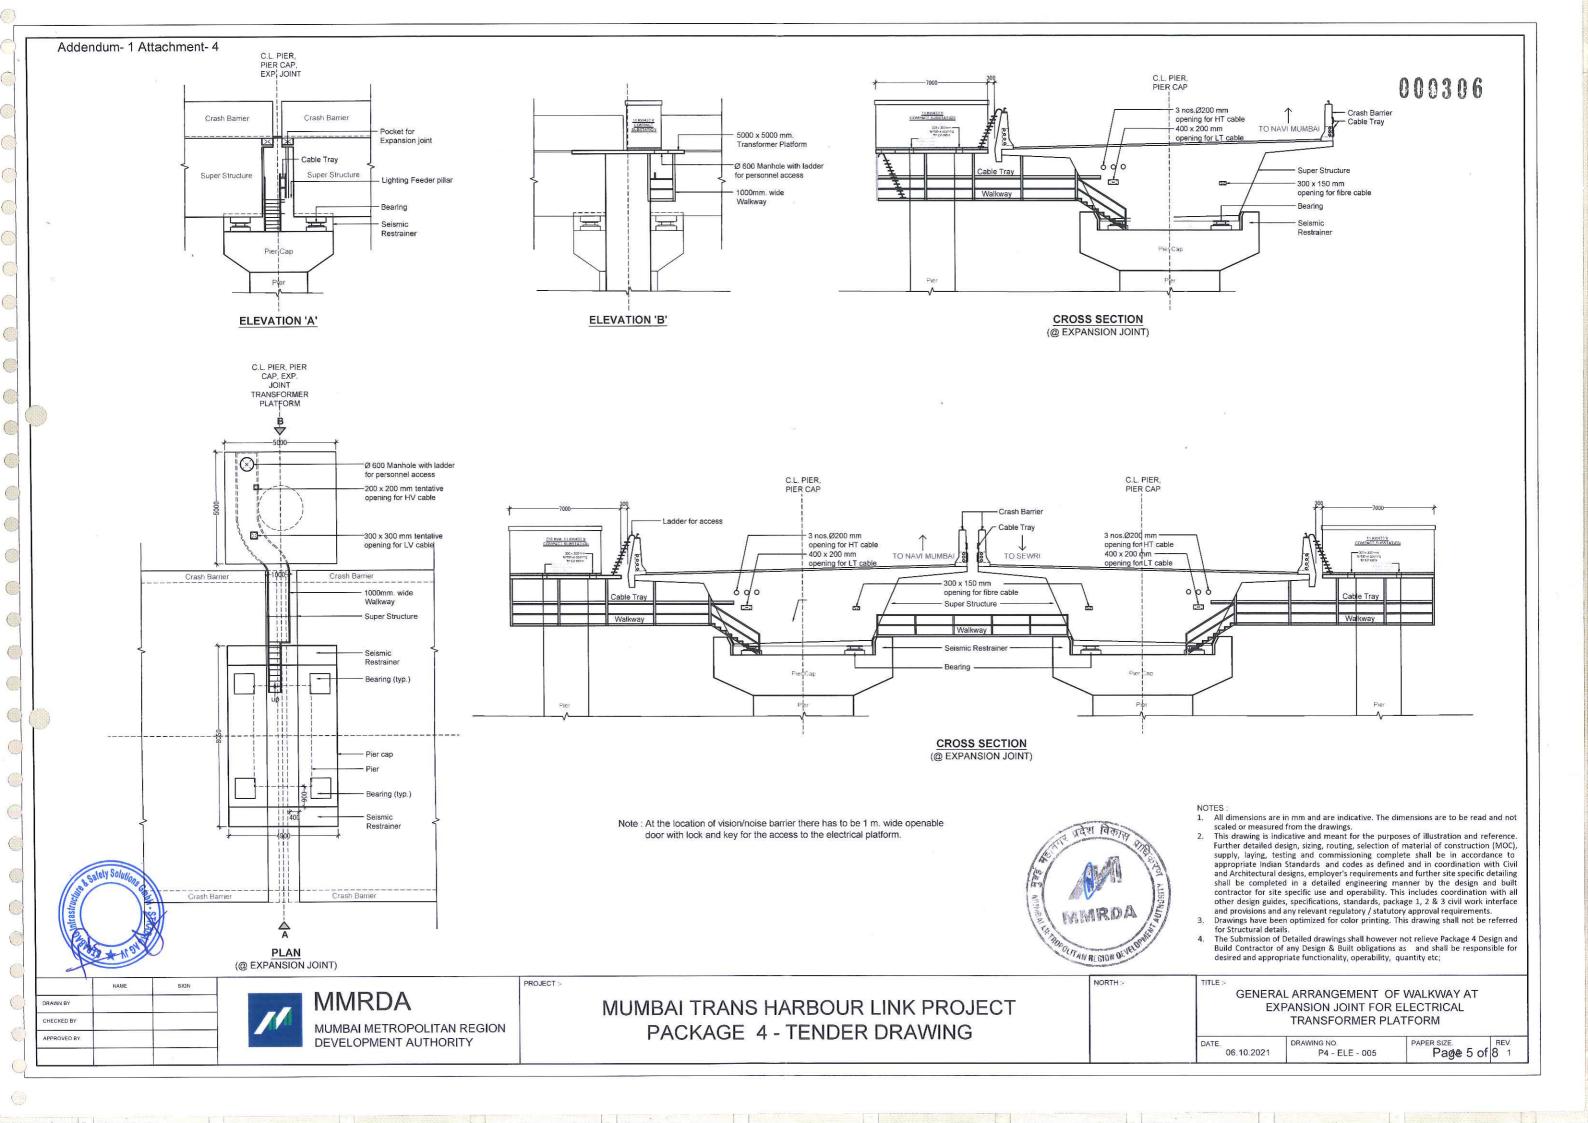

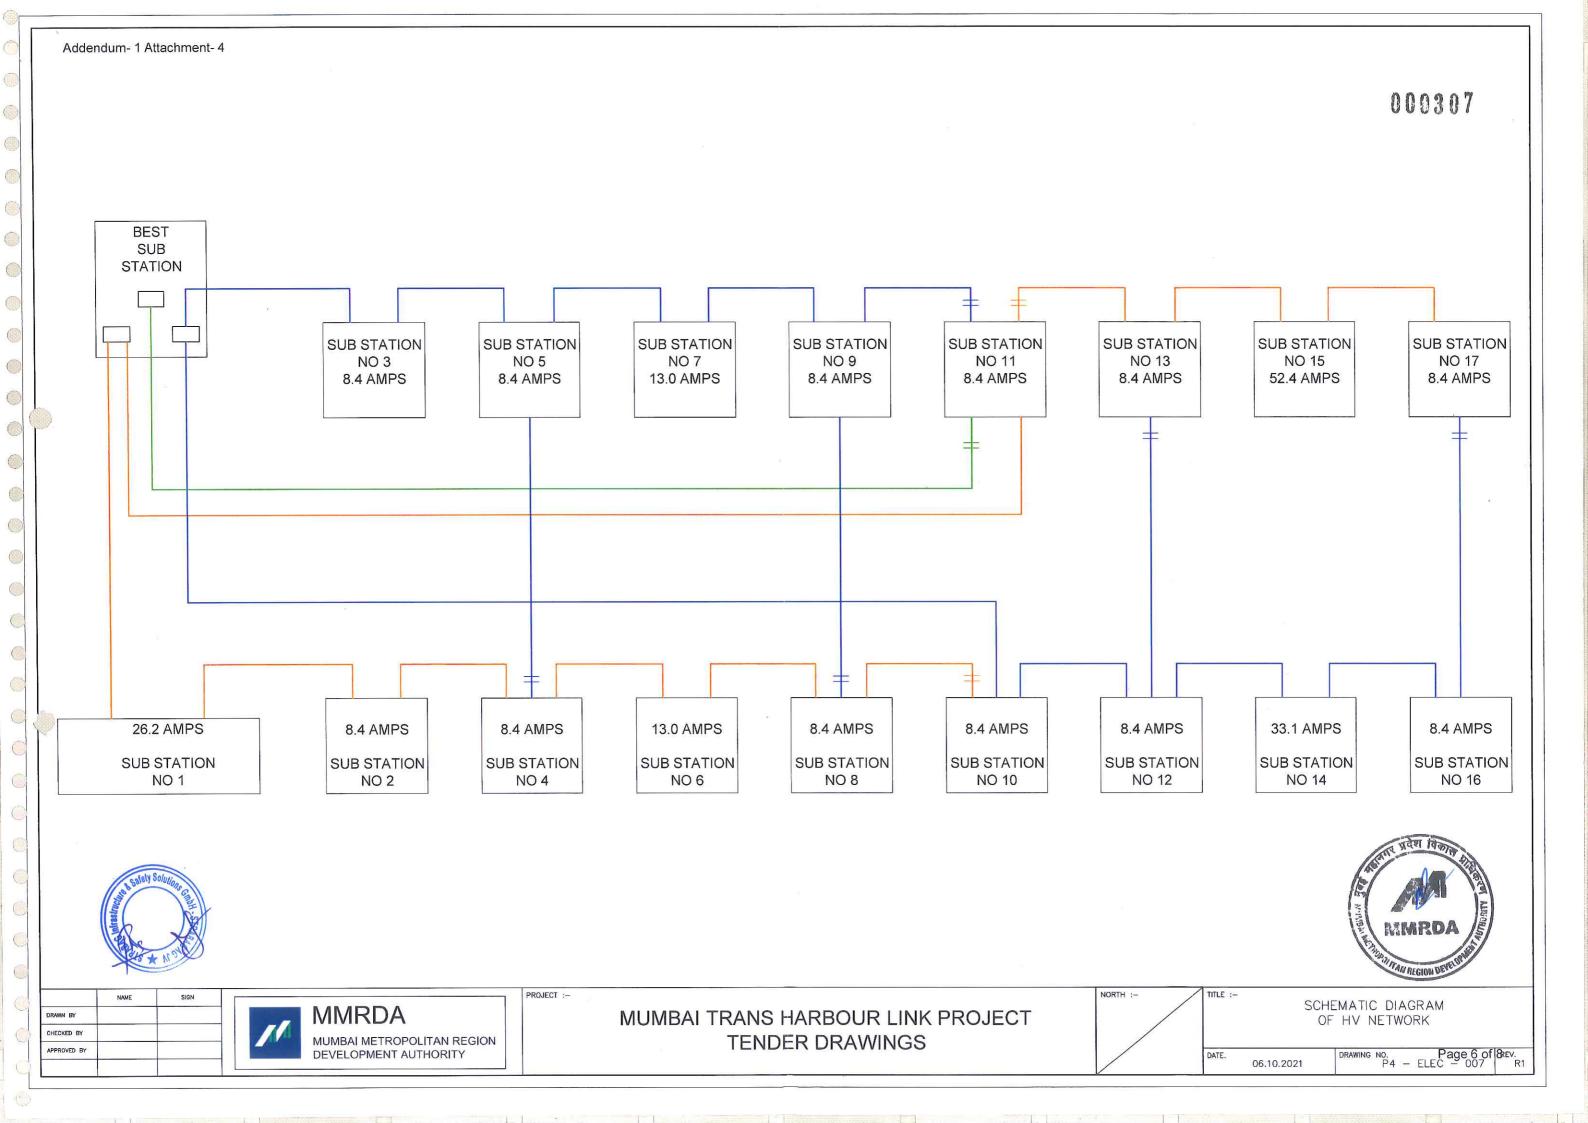

Addendum- 1 Attachment- 4

GENERAL

1) ALL DIMENSION ARE IN mm UNLESS SPECIFIED.

2) ALL DUCTS SHALL BE FABRICATED AS PER RELEVANT SMACNA STANDARD DUCT CONSTRUCTION. PRESSURE RATING OF THE DUCTS AS PER STATIC PRESSURE REQUIREMENT DUCT DESIGN AND FABRICATION SHALL BE AS PER AWS SPECIFICATION DOR AIR DISTRIBUTION SECTION 233113.

3) SERVICES IN SHAFT TO BE COORDINATED WITH OTHER SERVICE.

- 4) ALL DUCT / PIPE LEVELS ARE INDICATIVE FROM FFL.
- ALL TOILET DOORS TO BE PROVIDED WITH 12 mm UNDER CUT FOR AIR TRANSFER INCASE FRESH AIR DIRECTLY NOT SUPPLIED TO TOILET.

6) ALL AHU ROOM / FAN ROOM DOOR SHOULD BE OPEN OUTSIDE.

7) ALL 90° MITERED ELBOWS SHALL HAVE DOUBLE THICKNESS TURNING VANES UNLESS OTHERWISE NOTED.

8) ALL SPECIFICATION AND EQUIPMENT SELECTION SHOULD MEET MINIMUM ECBC 2016 (LATEST).

9) FIRE DAMPERS TO BE PROVIDED IN SUPPLY AIR AND RETURN AIR DUCTS WHILE CROSSING FIRE RATED PARTITION OR AS SHOWN ON DRAWINGS.

10) ACCESS DOORS ON THE DUCTS / PLENUM SHALL BE MINIMUM 450 x 450 WHEREVER APPLICABLE.

- 11) PROVIDE HIGH POINT VENTS AND LOW POINT DRAINS ON ALL PIPING AS APPLICABLE SUCH DRAIN POINTS ARE CONSIDERED AS PIPING ACCESSORIES ALL DRAIN AND VENT POINT MAY NOT BE SHOWN IN THE DRAWING / SCHEMATICS.
- 12) NO LIQUID CARRYING PIPES SHALL BE ROUTED ABOVE ELECTRICAL EQUIPMENT. IF THE SAME IS UNAVOIDABLE THEN SUCH PIPE SHALL RUN THROUGH 1.2mm THICK DRAIN TRAY SLOPED AWAY FROM EQUIPMENT.
- 13) ALL PIPES INSTALLED INSIDE THE MECHANICAL PLANT ROOM, FAN ROOM SHALL BE SUPPORTED WITH SEISMIC ISOLATOR FOR RELEVANT EARTHQUAKE ZONE.
- 14) ALL VALVES & OTHER EQUIPMENT SHOWN IN WALLS OR ABOVE NON-ACCESSIBLE CEILINGS SHALL BE INSTALLED WITH ACCESS
- 15) ALL PIPE PENETRATION THROUGH FIRE RATED WALLS OR FLOORS SHALL BE FIRE STOPPED USING FIRE STOP SYSTEM BY MEP CONTRACTOR.
- 16) MANUAL VOLUME CONTROL DAPMERS SHALL BE PROVIDED IN ALL DUCTS BRANCHES UNLESS OTHERWISE NOTED. MANUAL BUILDING CODE OF INDIA.
- 17) ALL MECHANICAL SYSTEM SHALL BE INSTALLED IN ACCORDANCE WITH THE CURRENT ADOPTED ADDITION OF THE NATIONAL BUILDING CODE OF INDIA.
- 18) PLEASE REFER FLOOR PLAN & SCHEMATIC FOR FACE VELOCITY, PRESSURE DROP & FACE AREA IN LAUVER, ALSO REFER ARCHITECTURAL DRAWINGS FOR LOUVERS CONING ON BUILDING FACADE.

19) DUCTS WITH ACOUSTIC LINING SHOULD BE THERMALLY INSULATED.

- 20) ALL DUCTS SHALL BE TOTALLY FREE FROM VIBRATIONS UNDER ALL CONDITIONS OF OPERATIONS.
- 21) EQUIPMENT SCHEDULE TO BE READ IN CONJUNCTION WITH FLOOR PLAN LAYOUT & SCHEMATIC.
- 22) SCHEMATIC DRAWING TO BE READ IN CONJUNCTION WITH FLOOR PLAN LAYOUTS.

23) FOR EQUIPMENT CAPACITY REFER TO EQUIPMENT SCHEDULE.

24) VRF PIPING TO BE DESIGN BY SPECIALIST VENDOR.

THE BUILDING STRUCTURE IN THE PROJECT ARE NOT DESIGNED FOR EQUIPMENT VIBRATIONS ALL THE EQUIPMENT USED FOR THE PROJECT SHALL INCORPORATED MEASURES TO ATTENUATE TRANSMISSION OF THE VIBRATION FROM OPERATING EQUIPMENT TO THE MAIN STRUCTURE THROUGH PASSIVE MEANS WITH PRIMARY AND SECONDARY MEASURES AS REQUIRED TO ACHIEVE MINIMUM 95% EFFICIENCY IN ISOLATION OF THE VIBRATIONS. THE VENDOR / SUPPLIER SHALL PROVIDE DETAILED INFORMATION REGARDING THE VIBRATION ISOLATION METHODS ADOPTED AND THE RESIDUAL VIBRATION IN THE EQUIPMENT BEING TRANSMITTED TO THE BUILDING VENDOR / SUPPLIER SHALL ALSO PROVIDE THE DETAILS OF ANY SUPPORT NEEDED FROM THE GENERAL CONTRACTOR IN ORDER TO IMPLEMENT THE SOLUTION. THE EFFECTIVENESS OF THE ISOLATION MEASURES PROVIDED FOR THE EQUIPMENT SHALL BE SUCCESSFULLY DEMONSTRATED FOR VARIOUS OPERATIONAL SCENARIOS AS PART OF THE TESTING AND COMMISSIONING STAGE PRIOR TO ACCEPTANCE BY CLIENT.



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CHECKED BY		_
APPROVED BY		




MUMBAI TRANS HARBOUR LINK PROJECT TENDER DRAWINGS


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	DATE.	06.10.2021	DRAWING	NO. P4	P: - HVAC	age 7 of 8	EΝ


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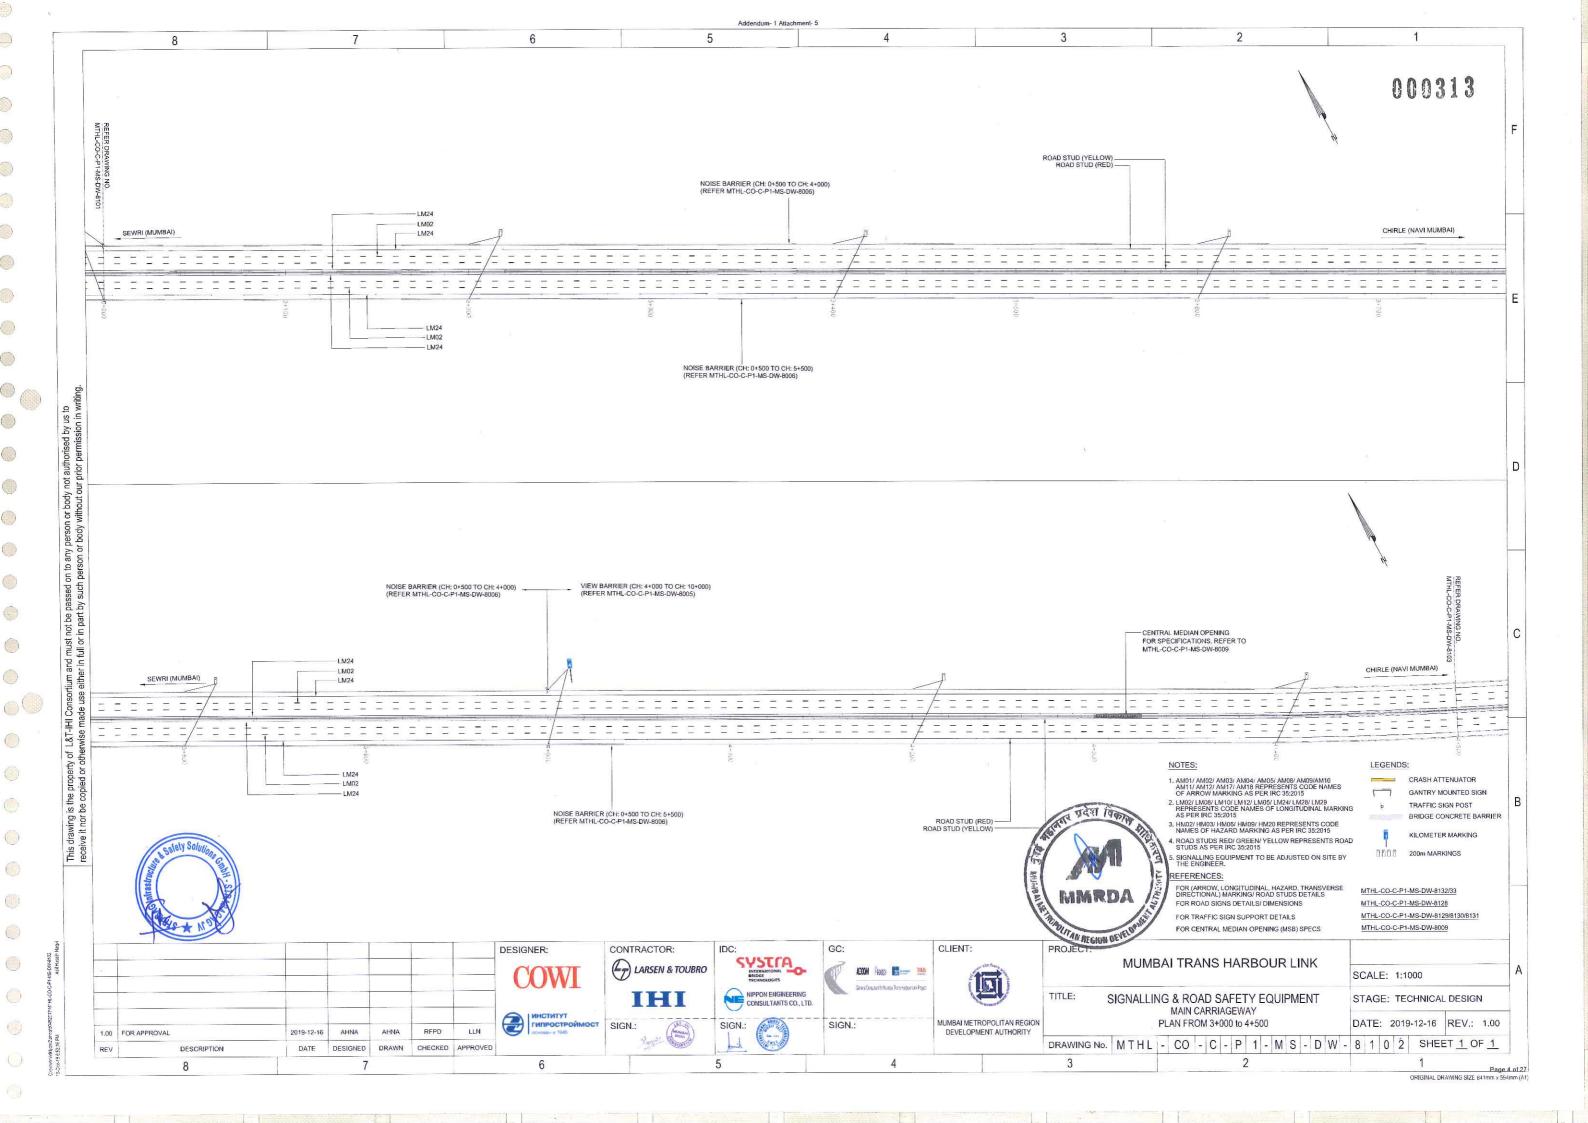
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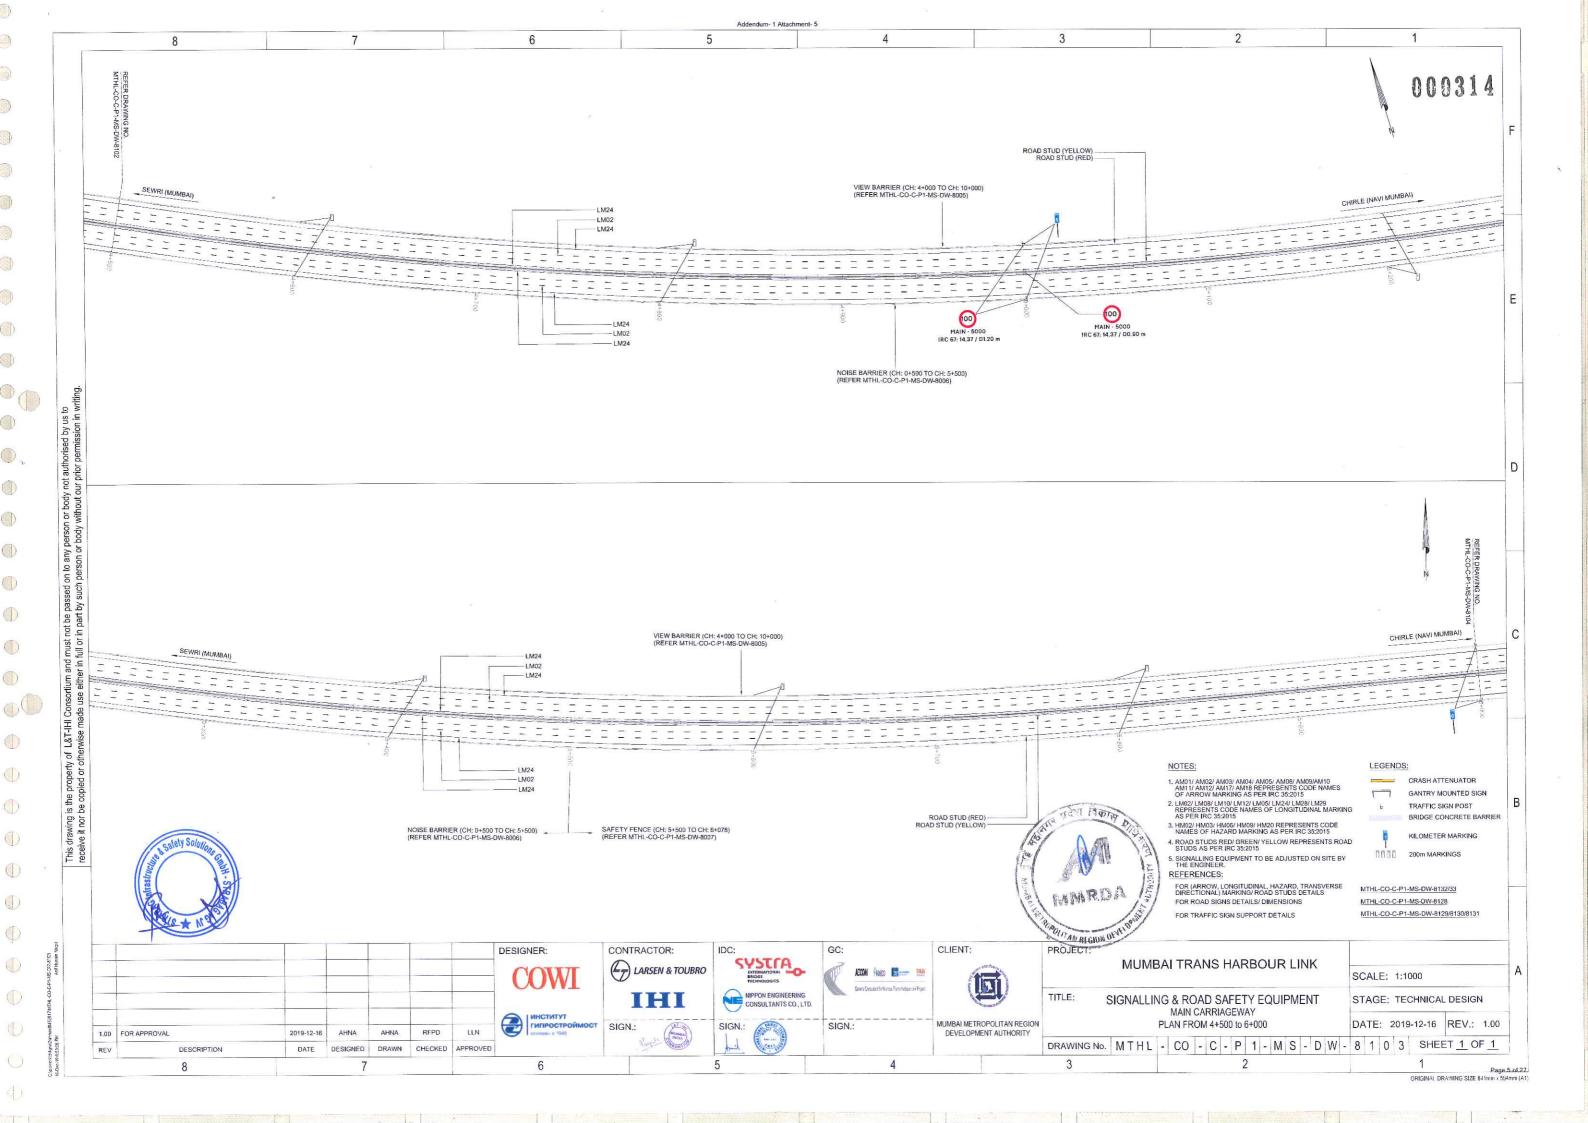
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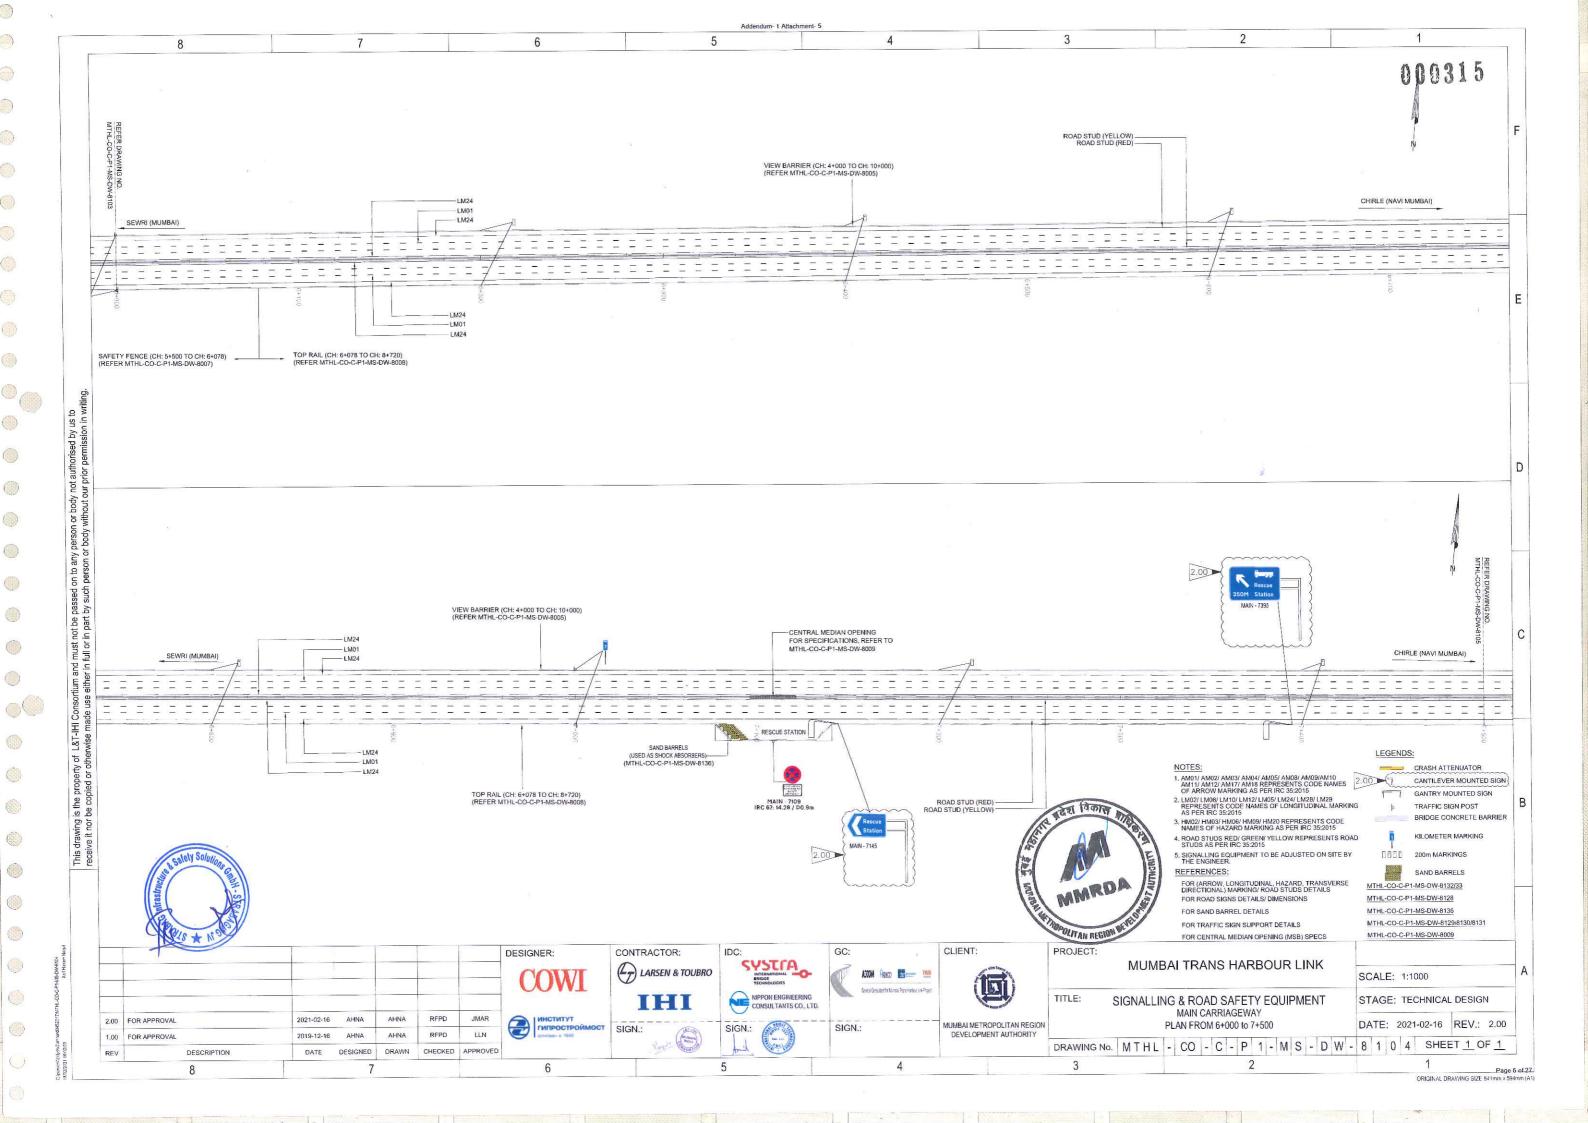








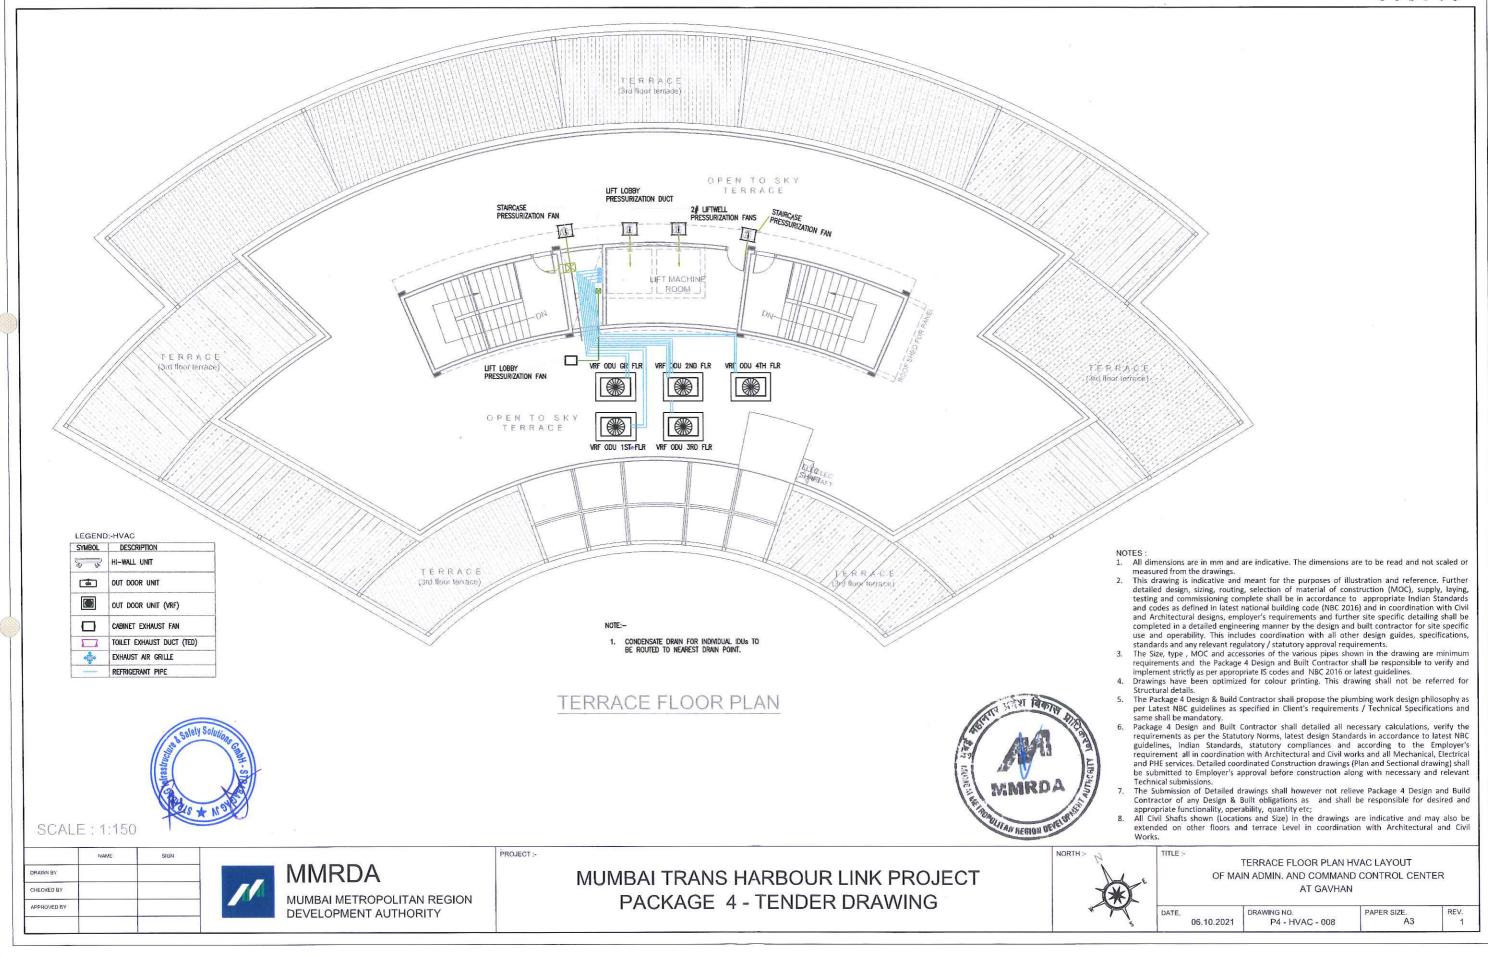


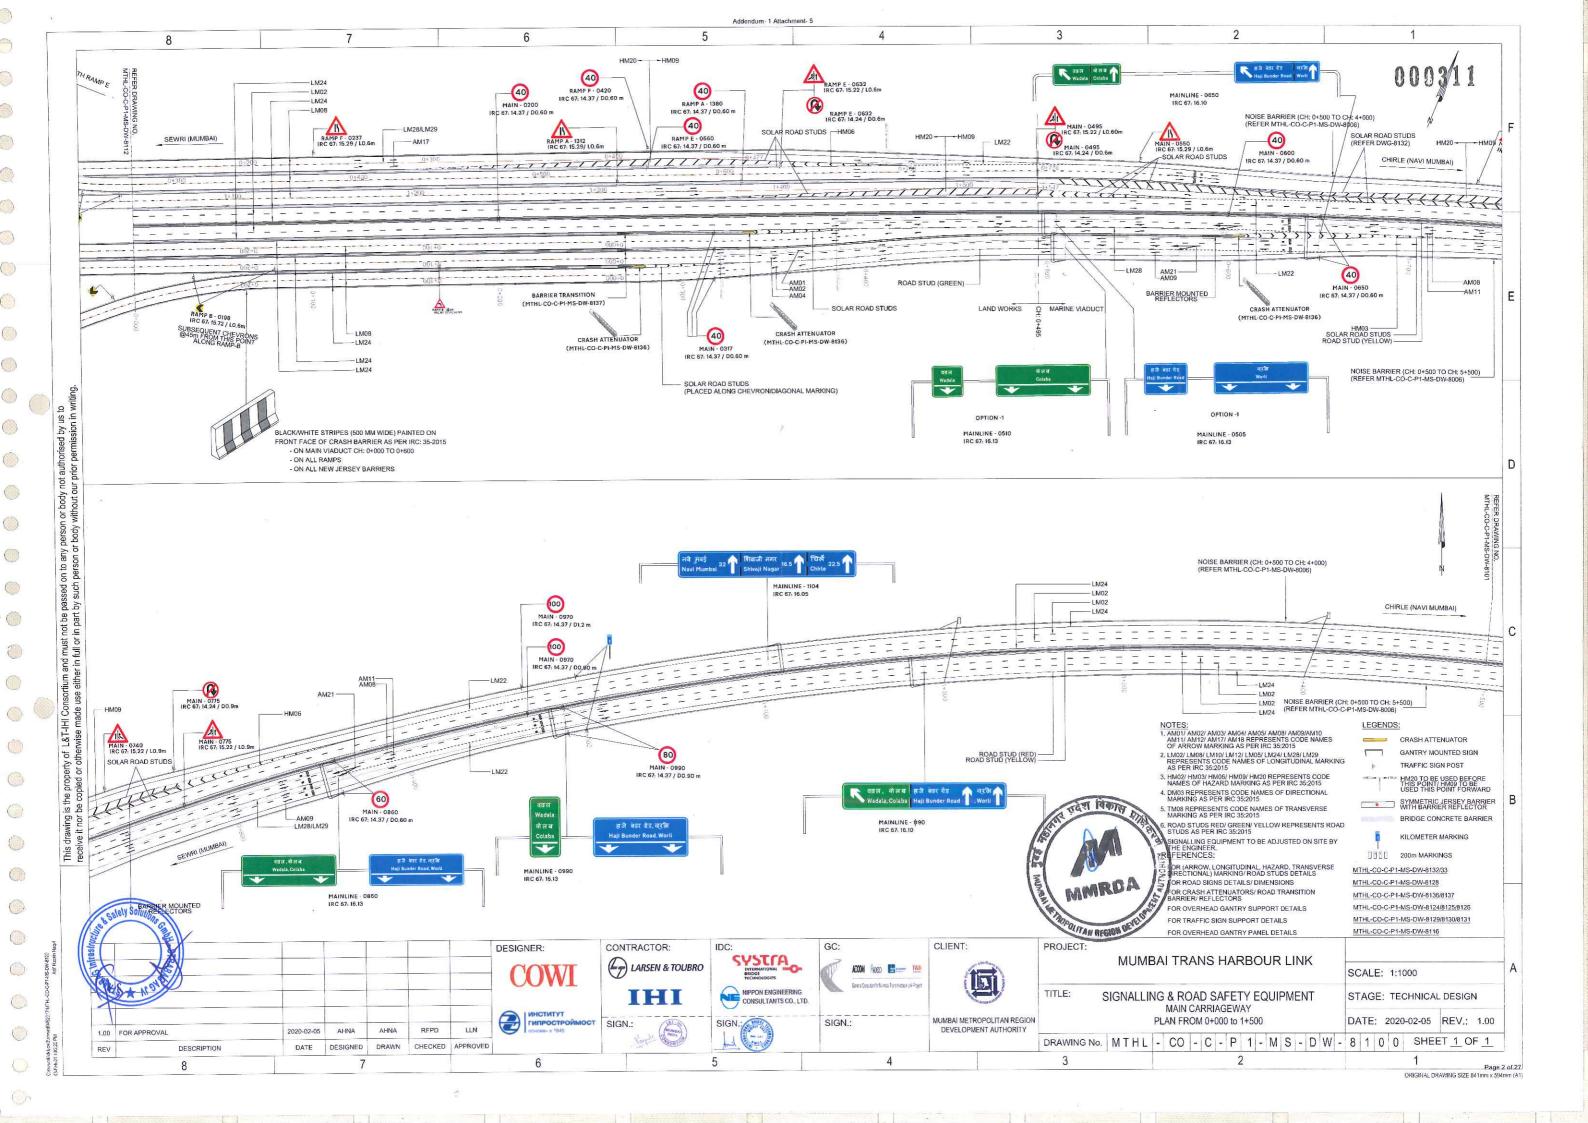


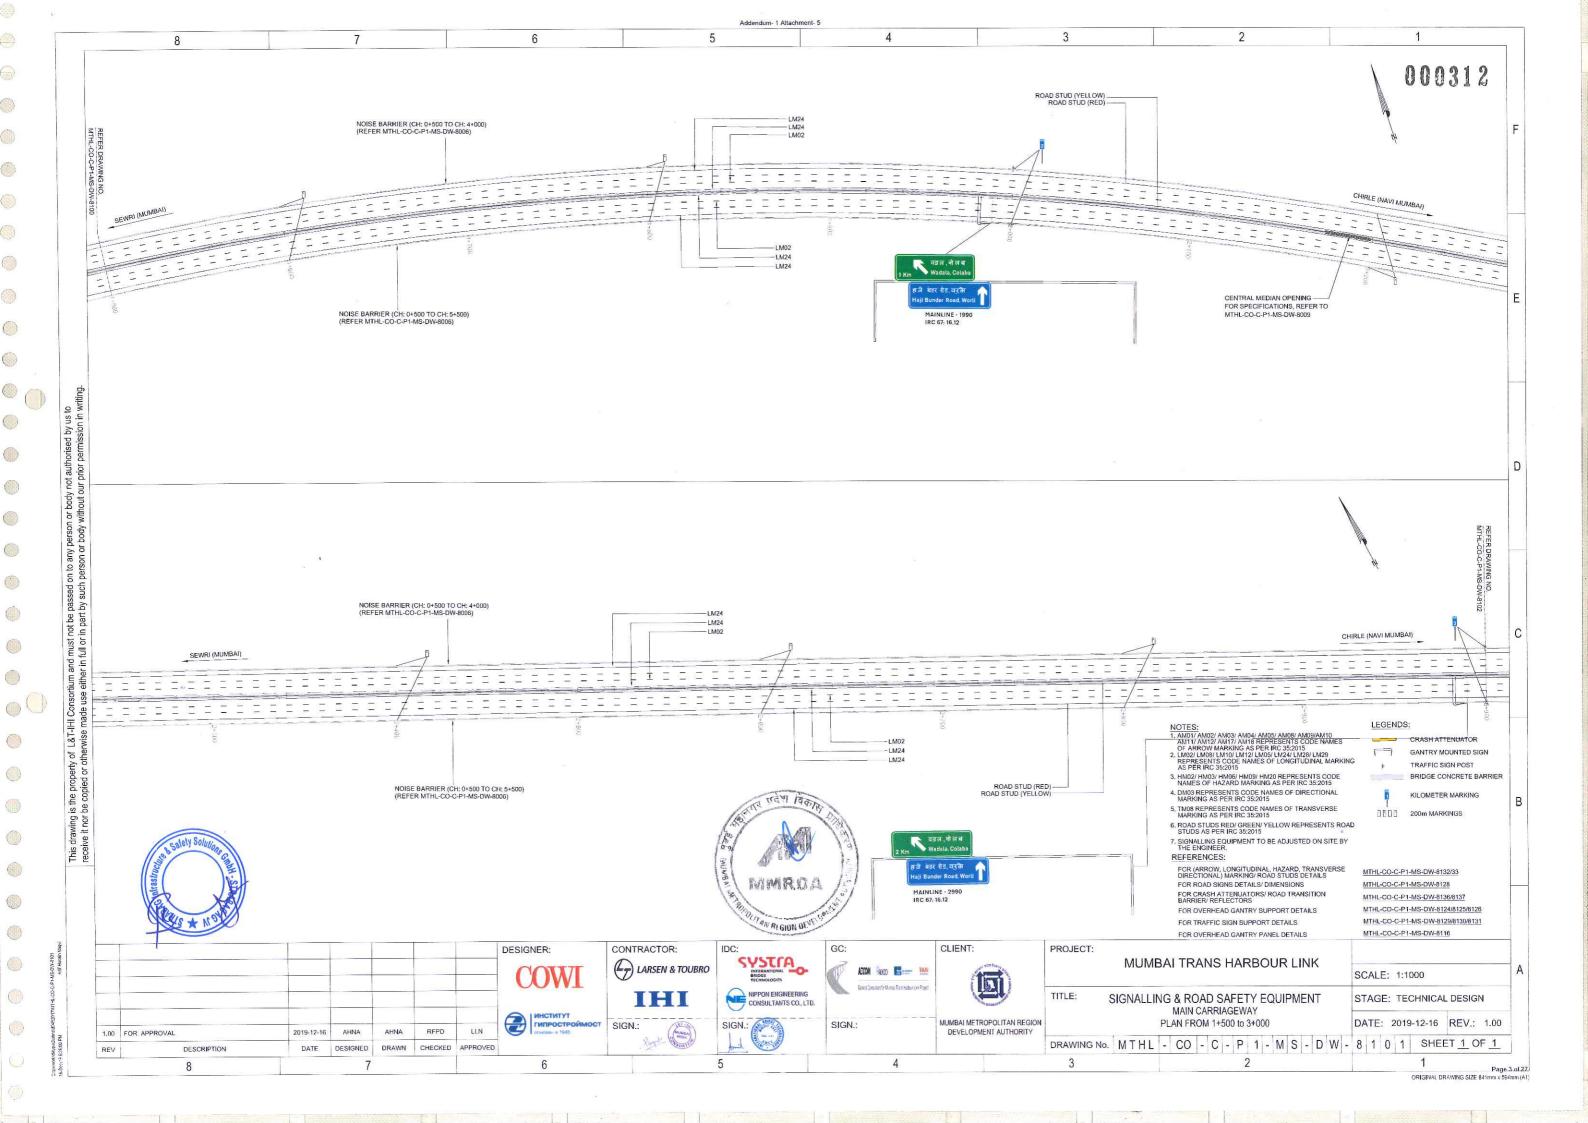


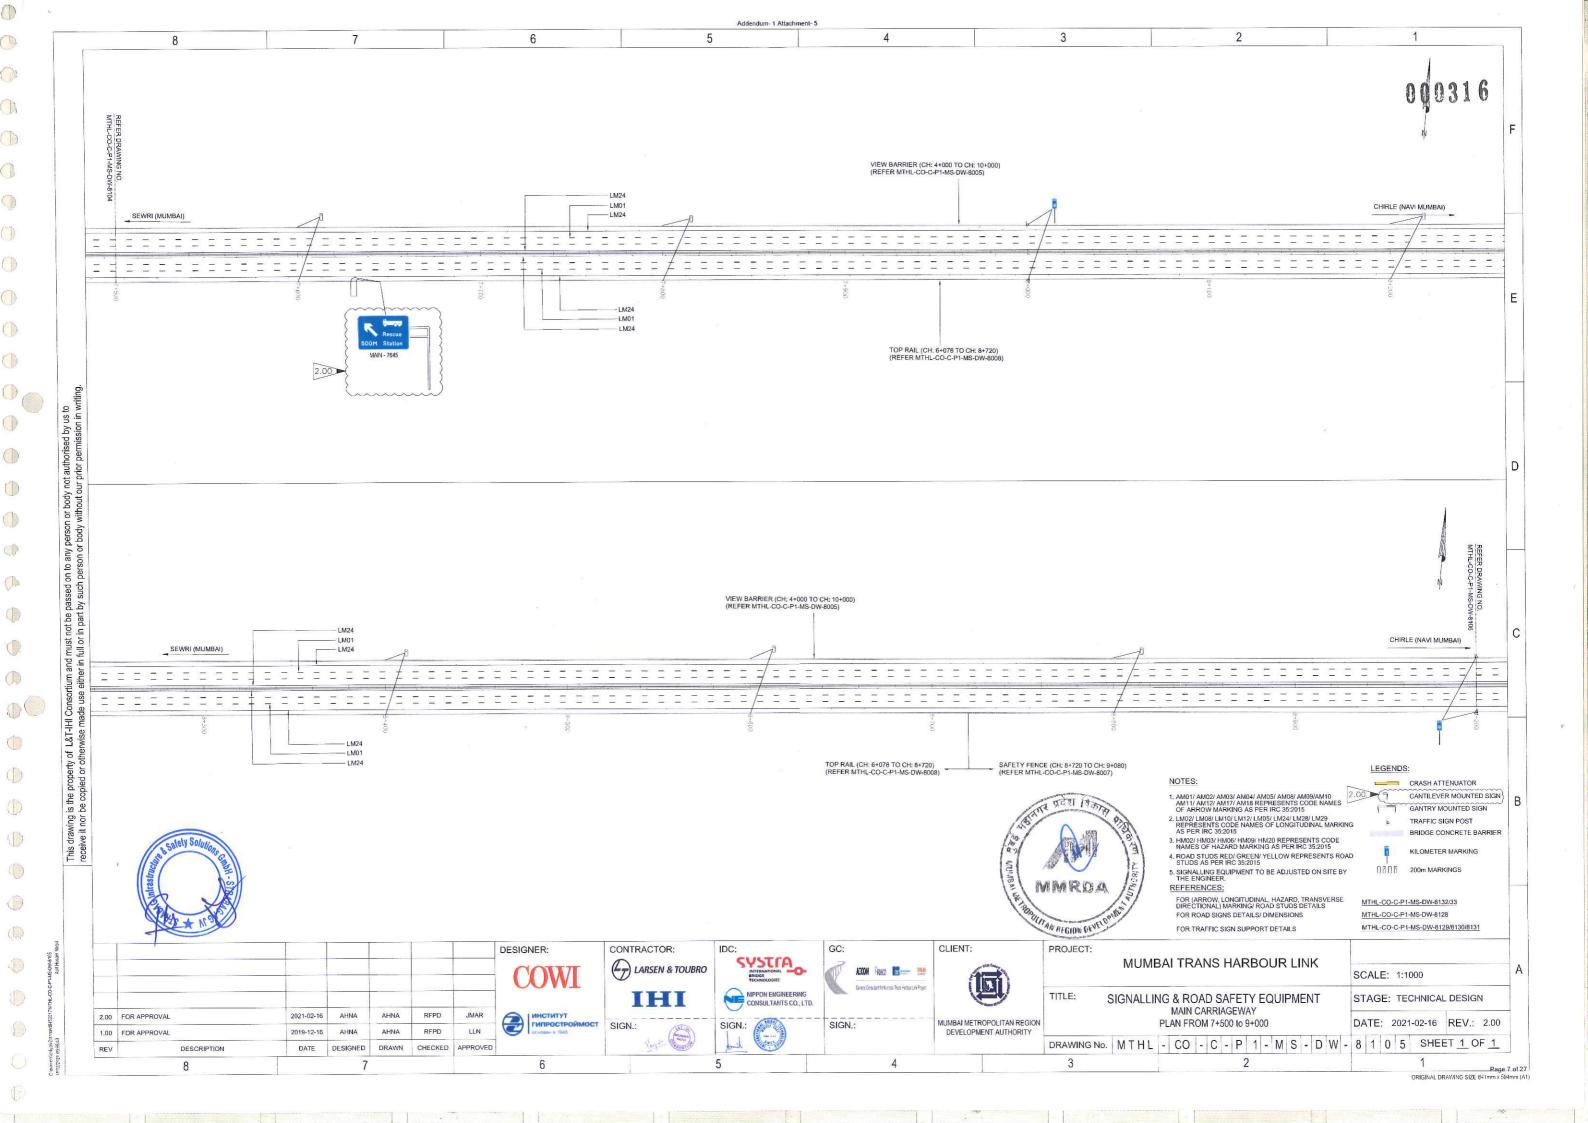


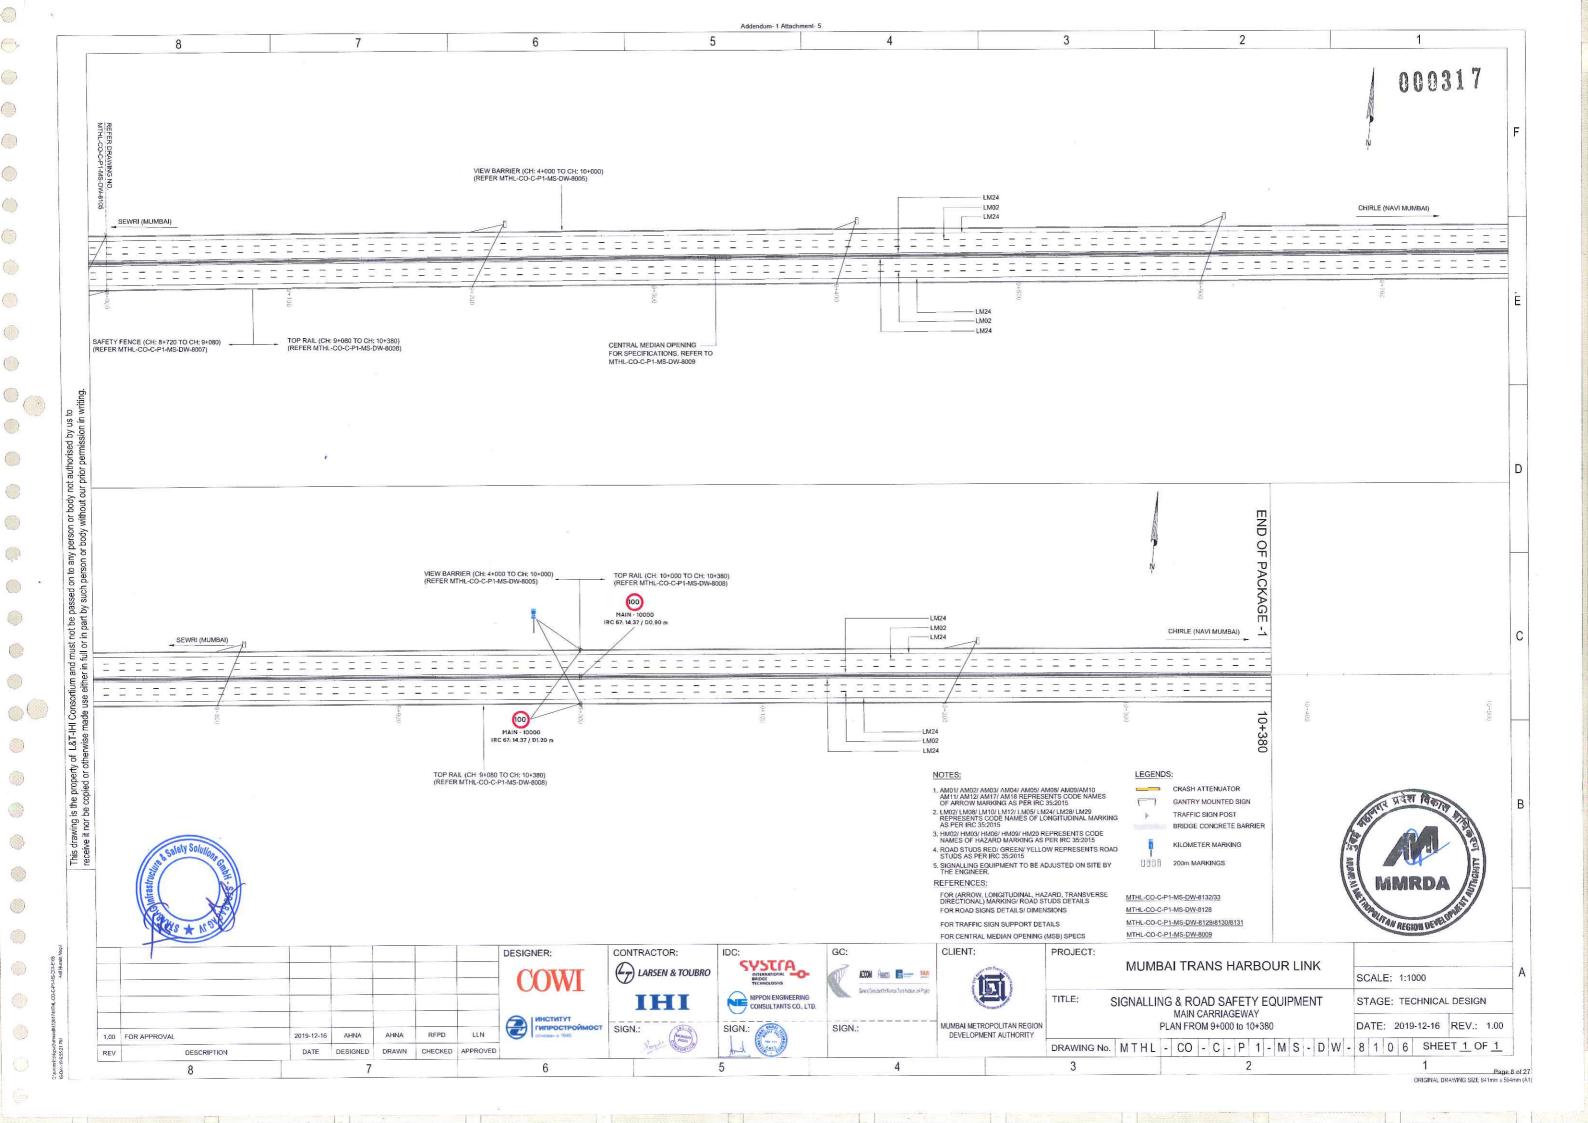


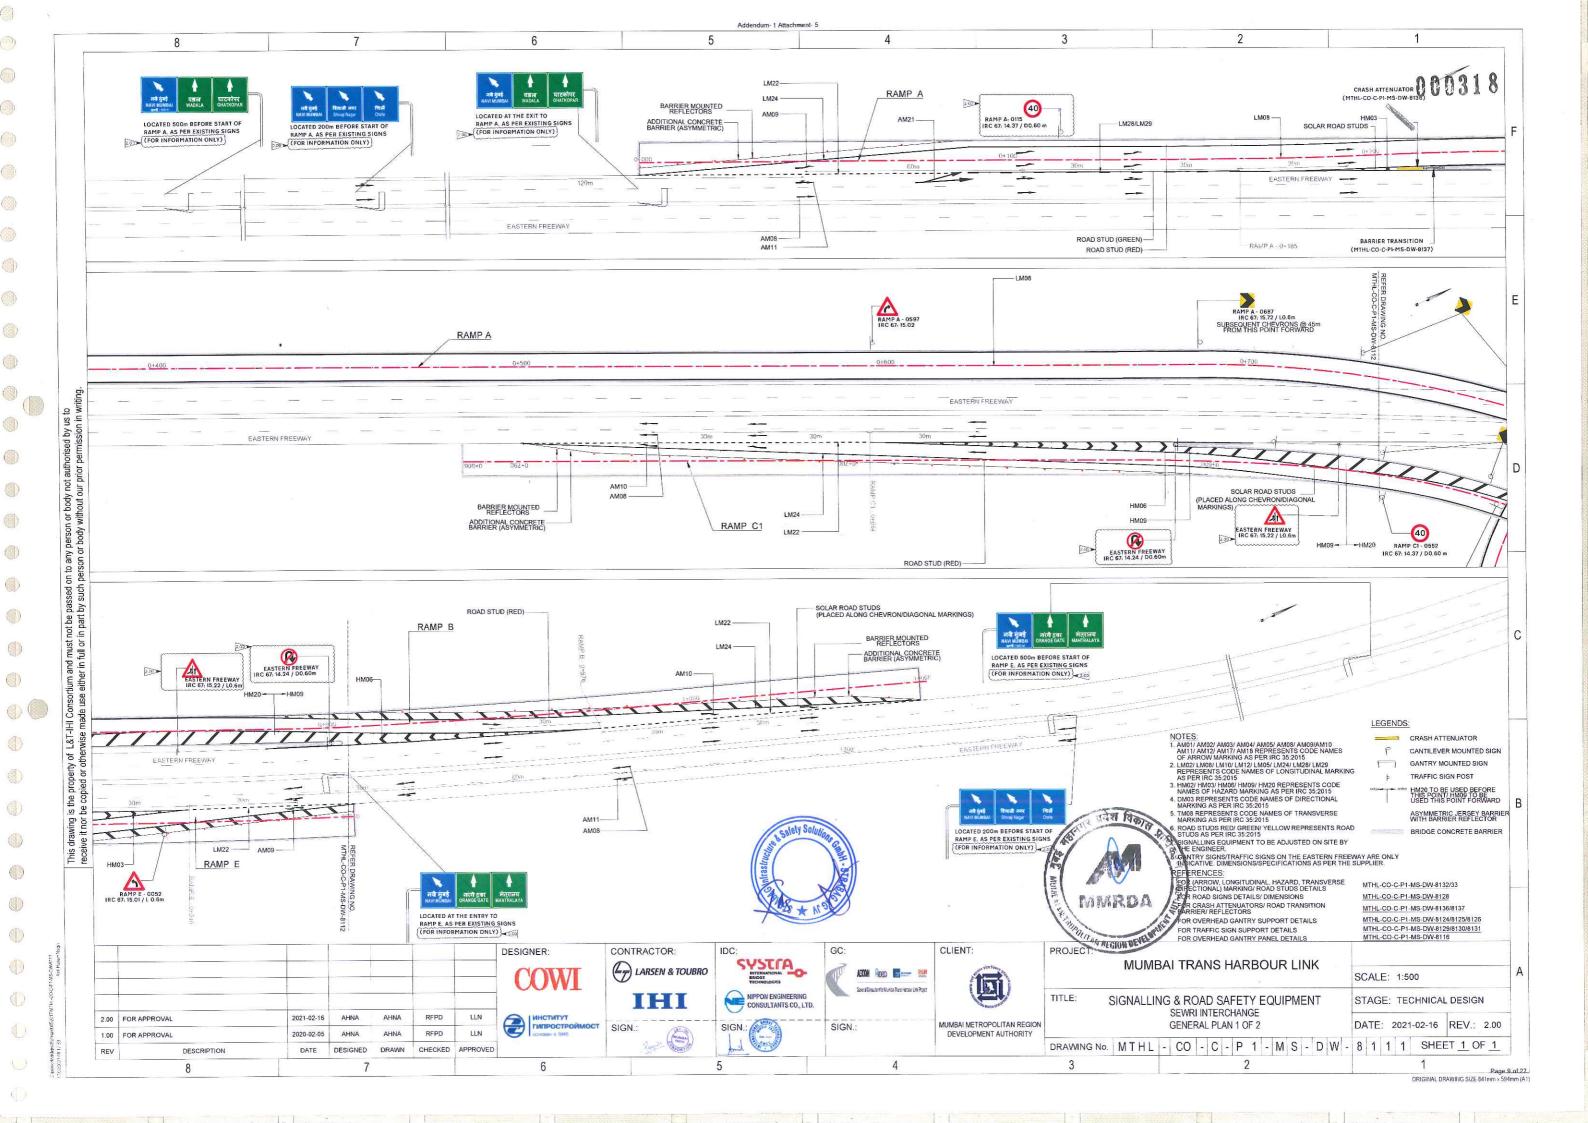

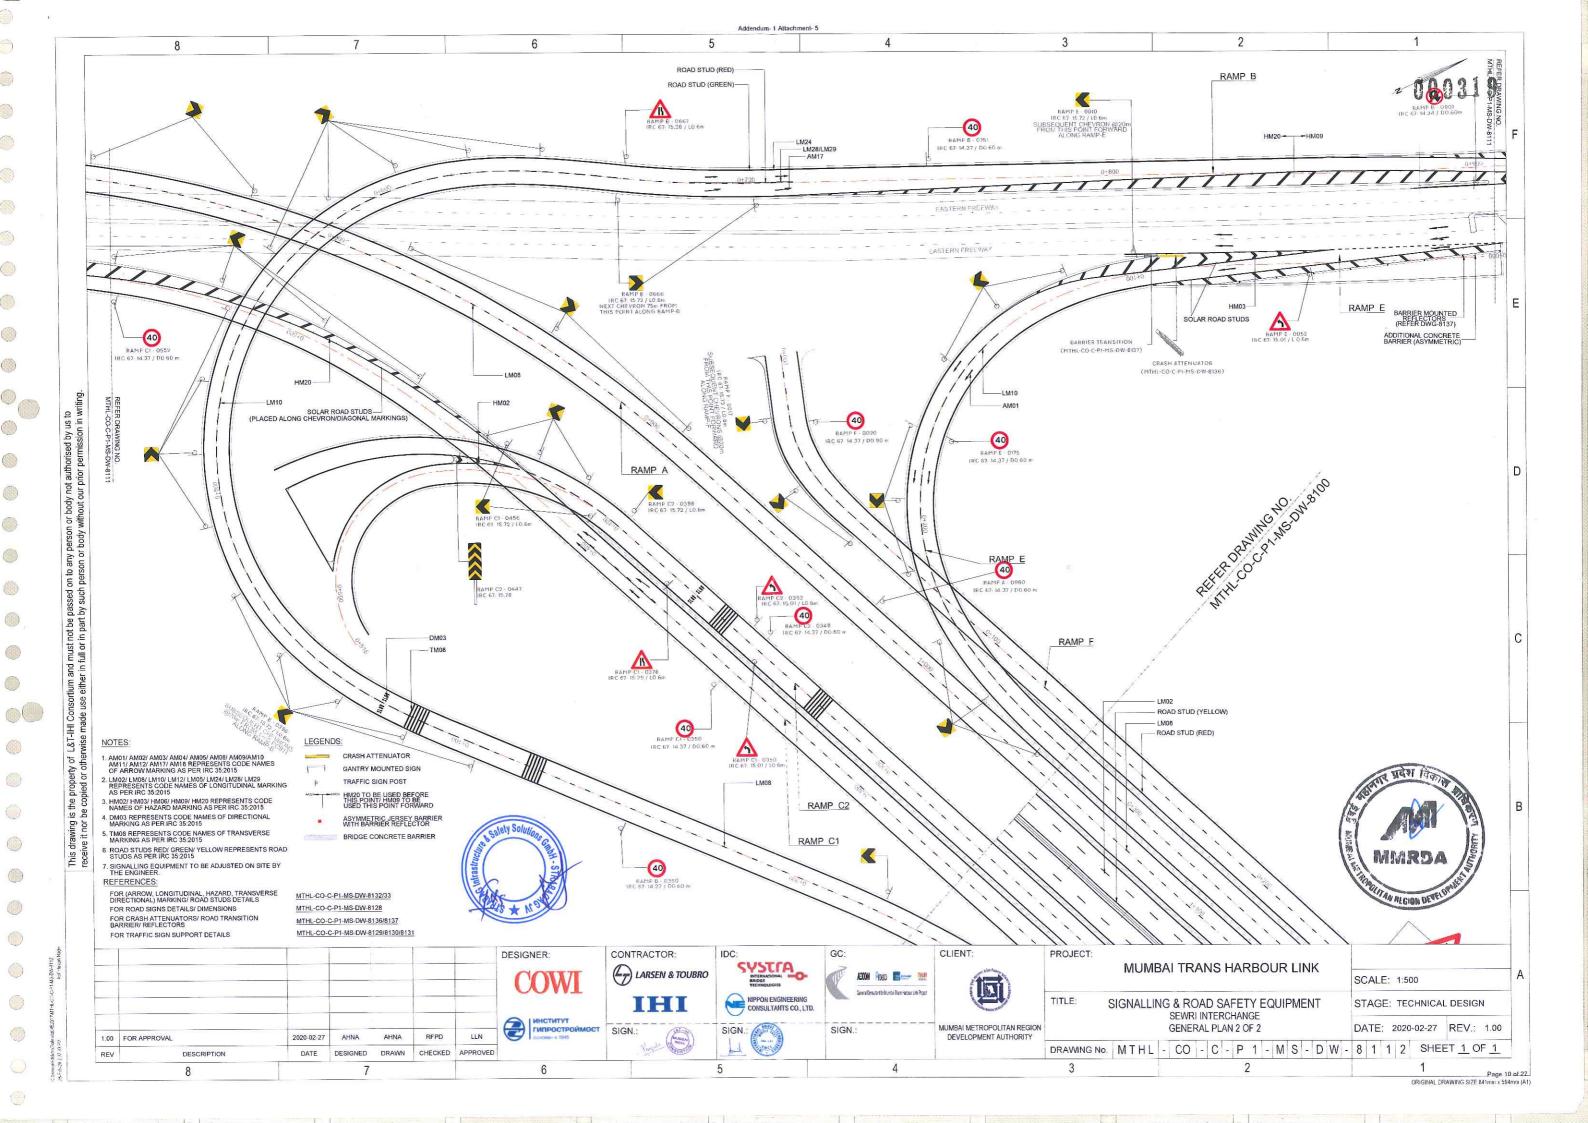

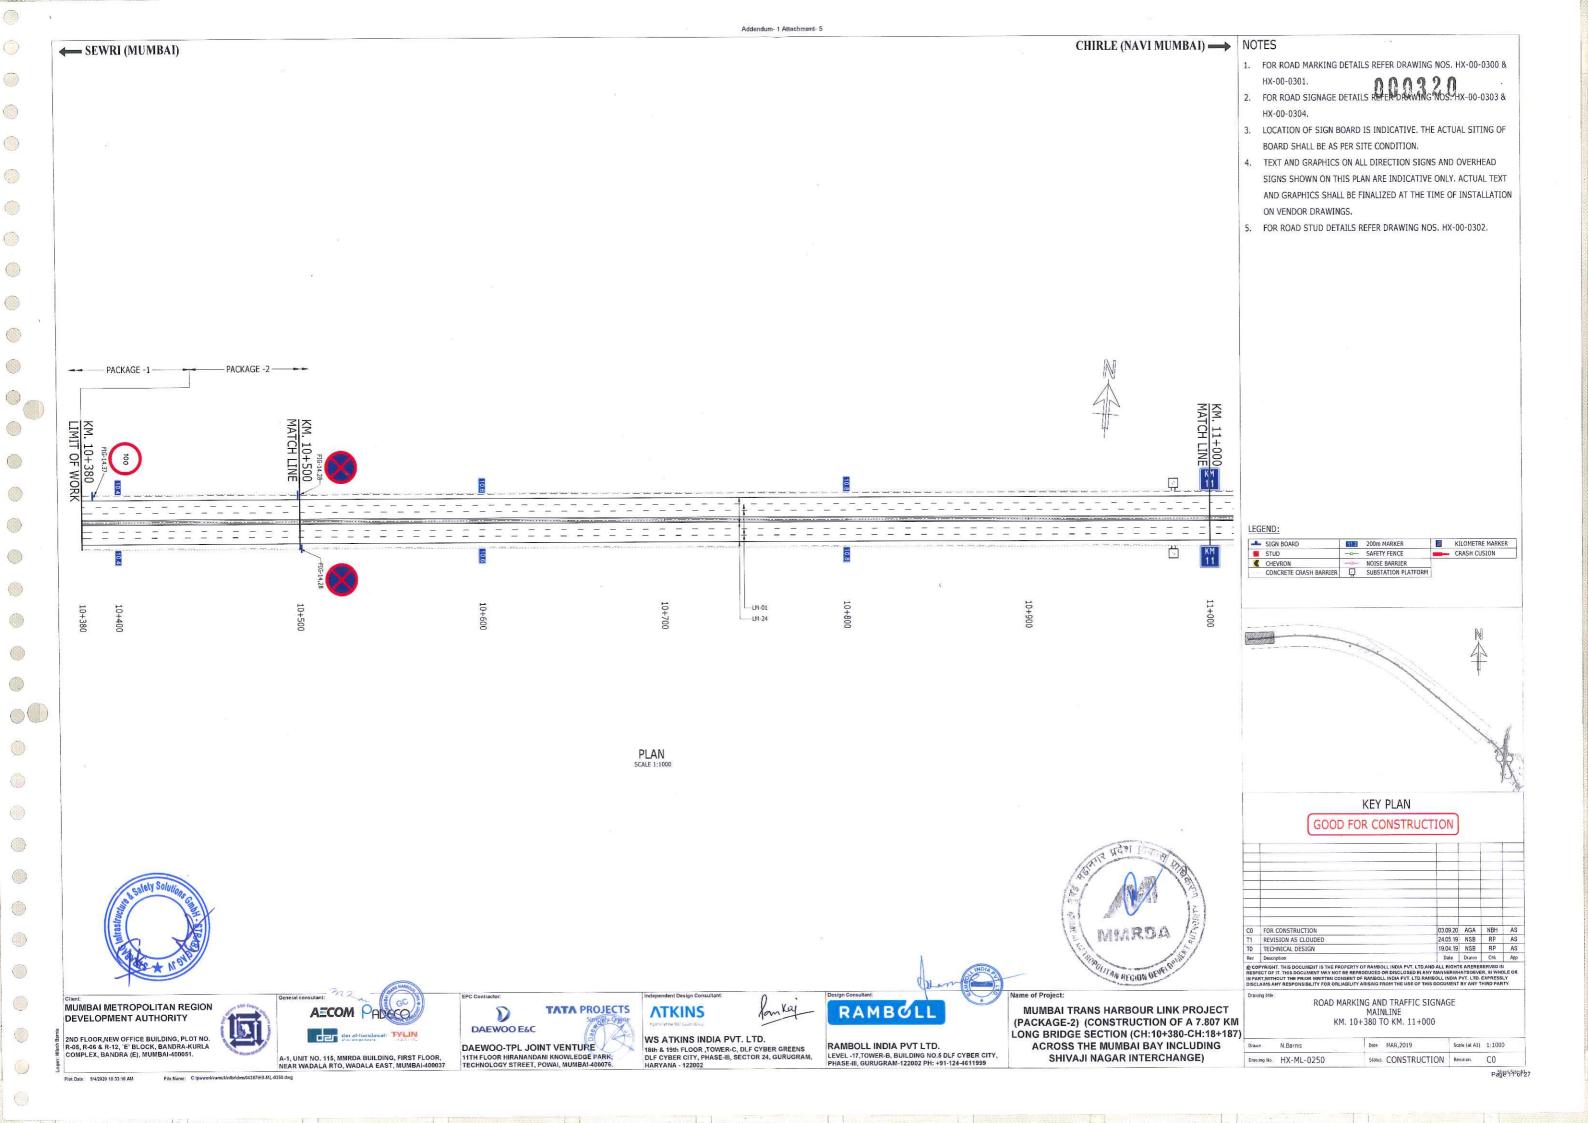

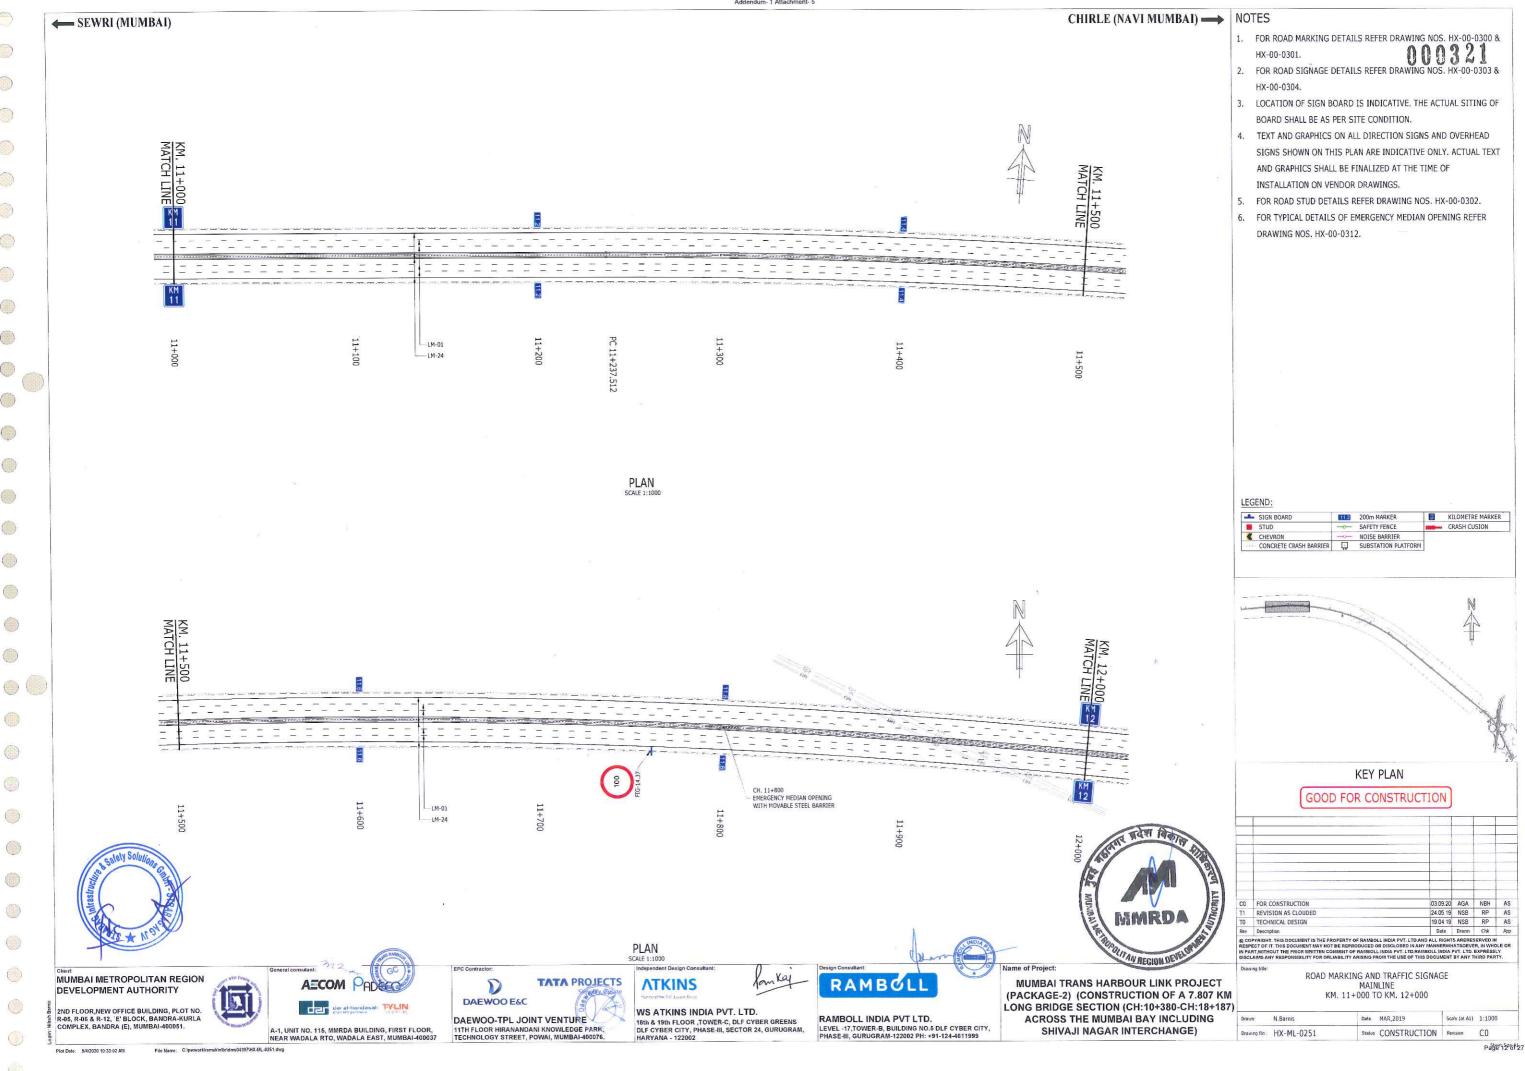

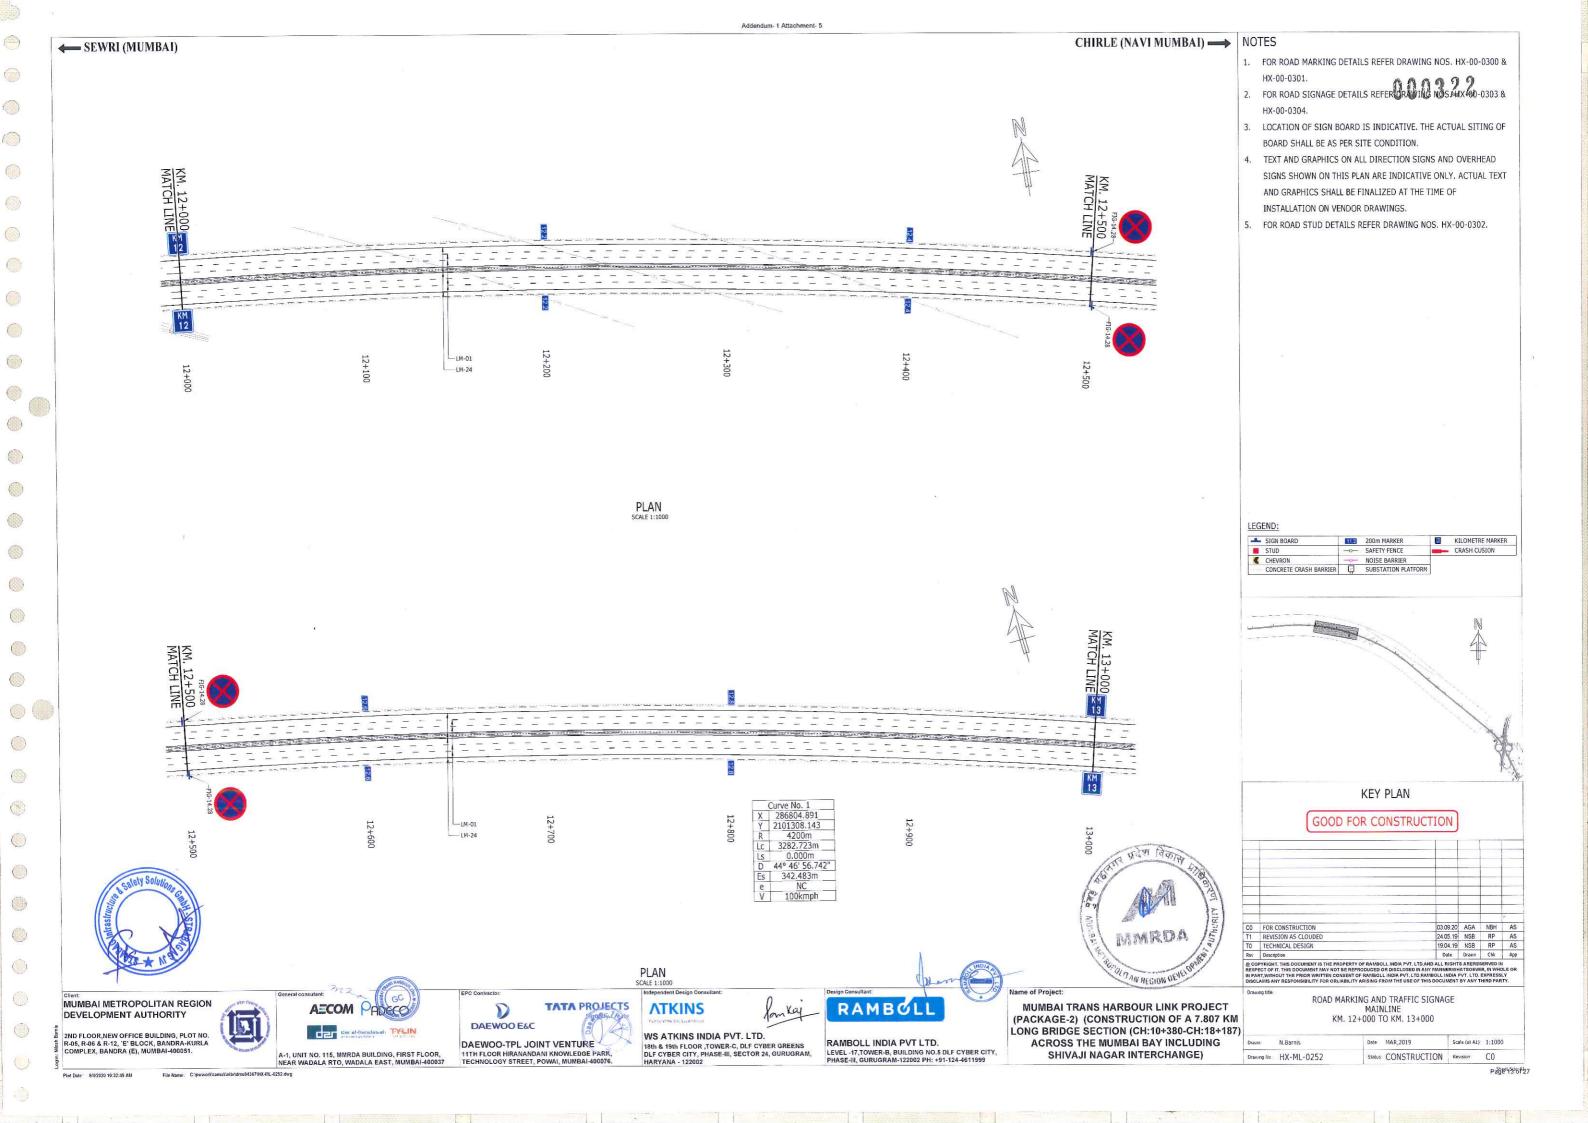

WS ATKINS INDIA PVT. LTD.

18th & 19th FLOOR ,TOWER-C, DLF CYBER GREENS DLF CYBER CITY, PHASE-III, SECTOR 24, GURUGRAM,

DAEWOO-TPL JOINT VENTURE
11TH FLOOR HIRANANDANI KNOWLEDGE PARK,
TECHNOLOGY STREET, POWAI, MUMBAI-400076.

A-1, UNIT NO. 115, MMRDA BUILDING, FIRST FLOOR, NEAR WADALA RTO, WADALA EAST, MUMBAI-400037

RAMBOLL INDIA PVT LTD.

ACROSS THE MUMBAI BAY INCLUDING

SHIVAJI NAGAR INTERCHANGE)

Scale (at A1): 1:1000

Date MAR,2019

Status CONSTRUCTION Revision

N.Barnis

Drawing No HX-ML-0253

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RAMBOLL

RAMBOLL INDIA PVT LTD.

MUMBAI TRANS HARBOUR LINK PROJECT

(PACKAGE-2) (CONSTRUCTION OF A 7.807 KM

LONG BRIDGE SECTION (CH:10+380-CH:18+187)

ACROSS THE MUMBAI BAY INCLUDING

KM. 14+000 TO KM. 15+000

Date: MAR,2019

Status CONSTRUCTION Revision

Scale (at A1) 1:1000

CO Page 15 6/27

N.Barnis

DEVELOPMENT AUTHORITY

2ND FLOOR,NEW OFFICE BUILDING, PLOT NO. R-05, R-06 & R-12, 'E' BLOCK, BANDRA-KURLA COMPLEX, BANDRA (E), MUMBAI-400051. 18th & 19th FLOOR ,TOWER-C, DLF CYBER GREENS DLF CYBER CITY, PHASE-III, SECTOR 24, GURUGRAM, HARYANA - 122002 LEVEL -17,TOWER-B, BUILDING NO.5 DLF CYBER CITY, PHASE-III, GURUGRAM-122002 PH: +91-124-4611999 A-1, UNIT NO. 115, MMRDA BUILDING, FIRST FLOOR, NEAR WADALA RTO, WADALA EAST, MUMBAI-400037 11TH FLOOR HIRANANDANI KNOWLEDGE PARK, TECHNOLOGY STREET, POWAI, MUMBAI-400076. SHIVAJI NAGAR INTERCHANGE) Drawing No.: HX-ML-0254 Plot Date: 9/4/2020 10:32:15 AM File Name: C.\pwwork\ramuk\nlt

WS ATKINS INDIA PVT. LTD.


ATKINS

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DAEWOO E&C

DAEWOO-TPL JOINT VENTURE

(33)

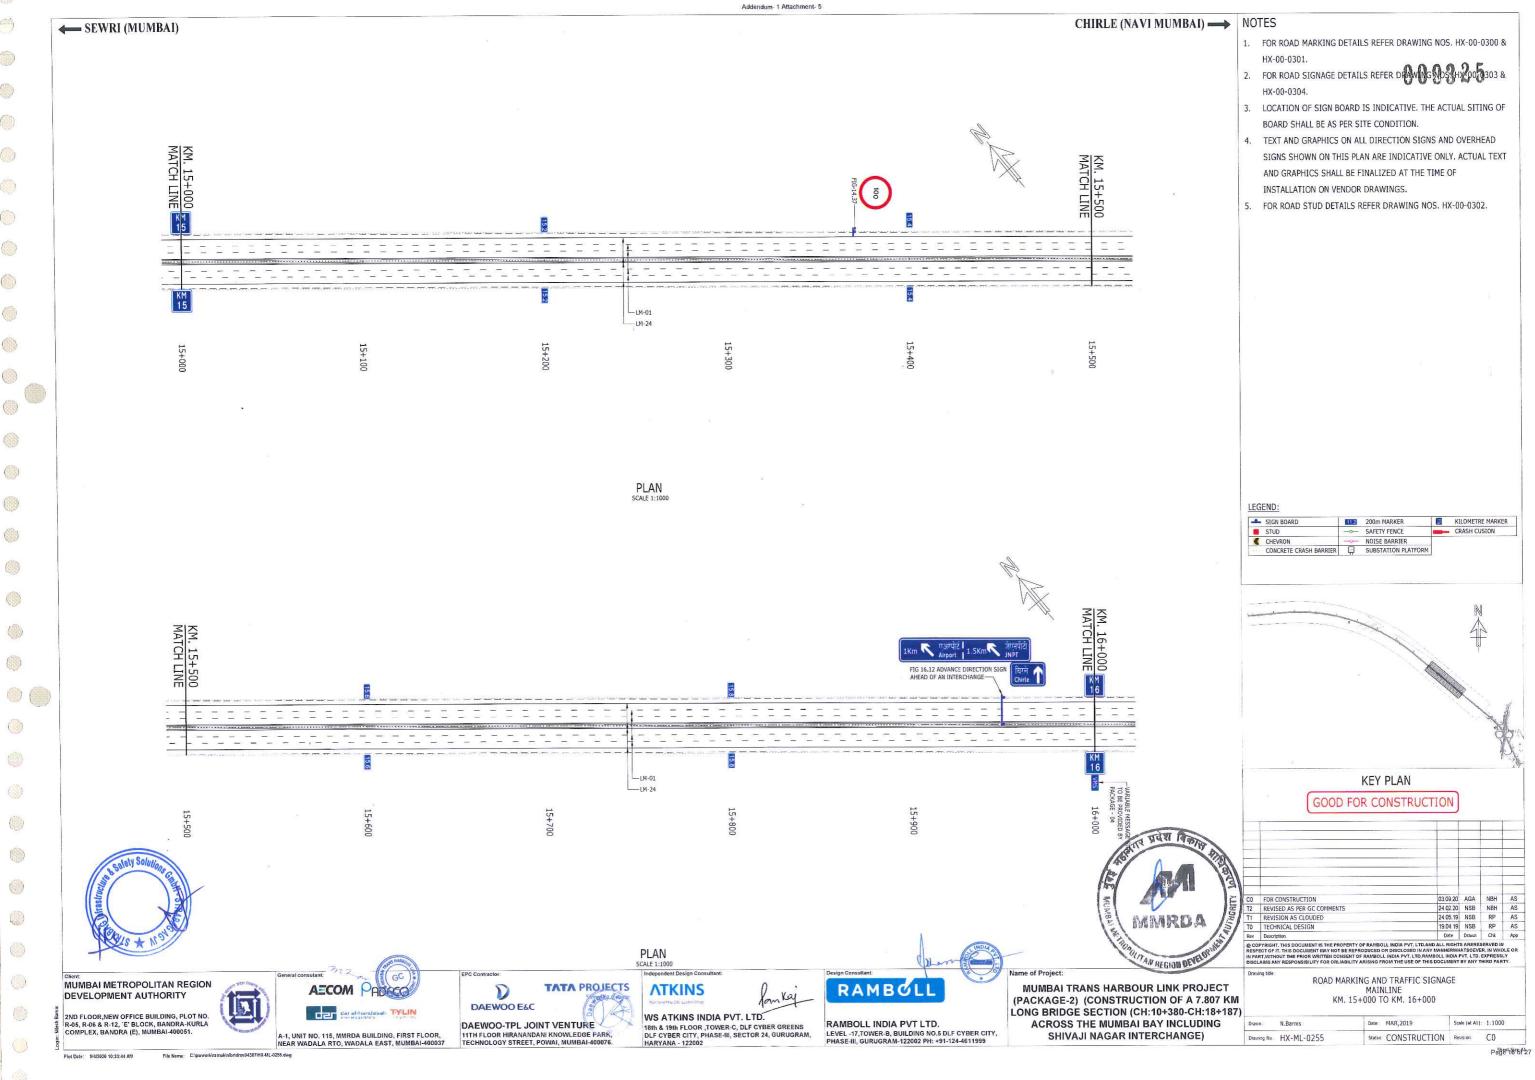

LEVEL -17, TOWER-B, BUILDING NO.6 DLF CYBER CITY, PHASE-III, GURUGRAM-122002 PH: +91-124-4611999

SHIVAJI NAGAR INTERCHANGE)

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Page 45 6/27

C1

Status CONSTRUCTION Revision:

Drawing No.: HX-ML-0256

Status CONSTRUCTION Revision

SHIVAJI NAGAR INTERCHANGE)


Drawing file HX-ML-0257

A-1, UNIT NO. 115, MMRDA BUILDING, FIRST FLOOR, NEAR WADALA RTO, WADALA EAST, MUMBAI-400037

11TH FLOOR HIRANANDANI KNOWLEDGE PARK, TECHNOLOGY STREET, POWAI, MUMBAI-400076.

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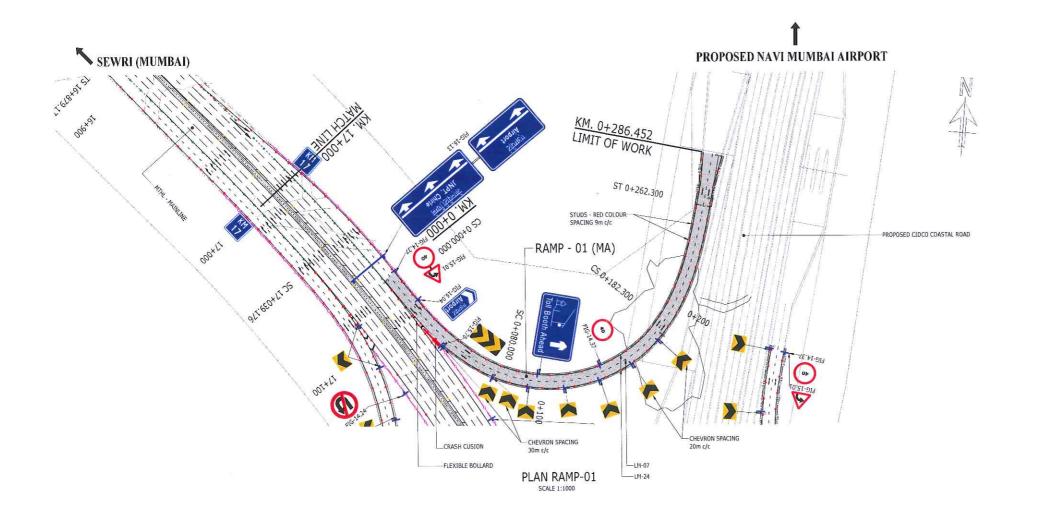


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SELECTION OF STREET

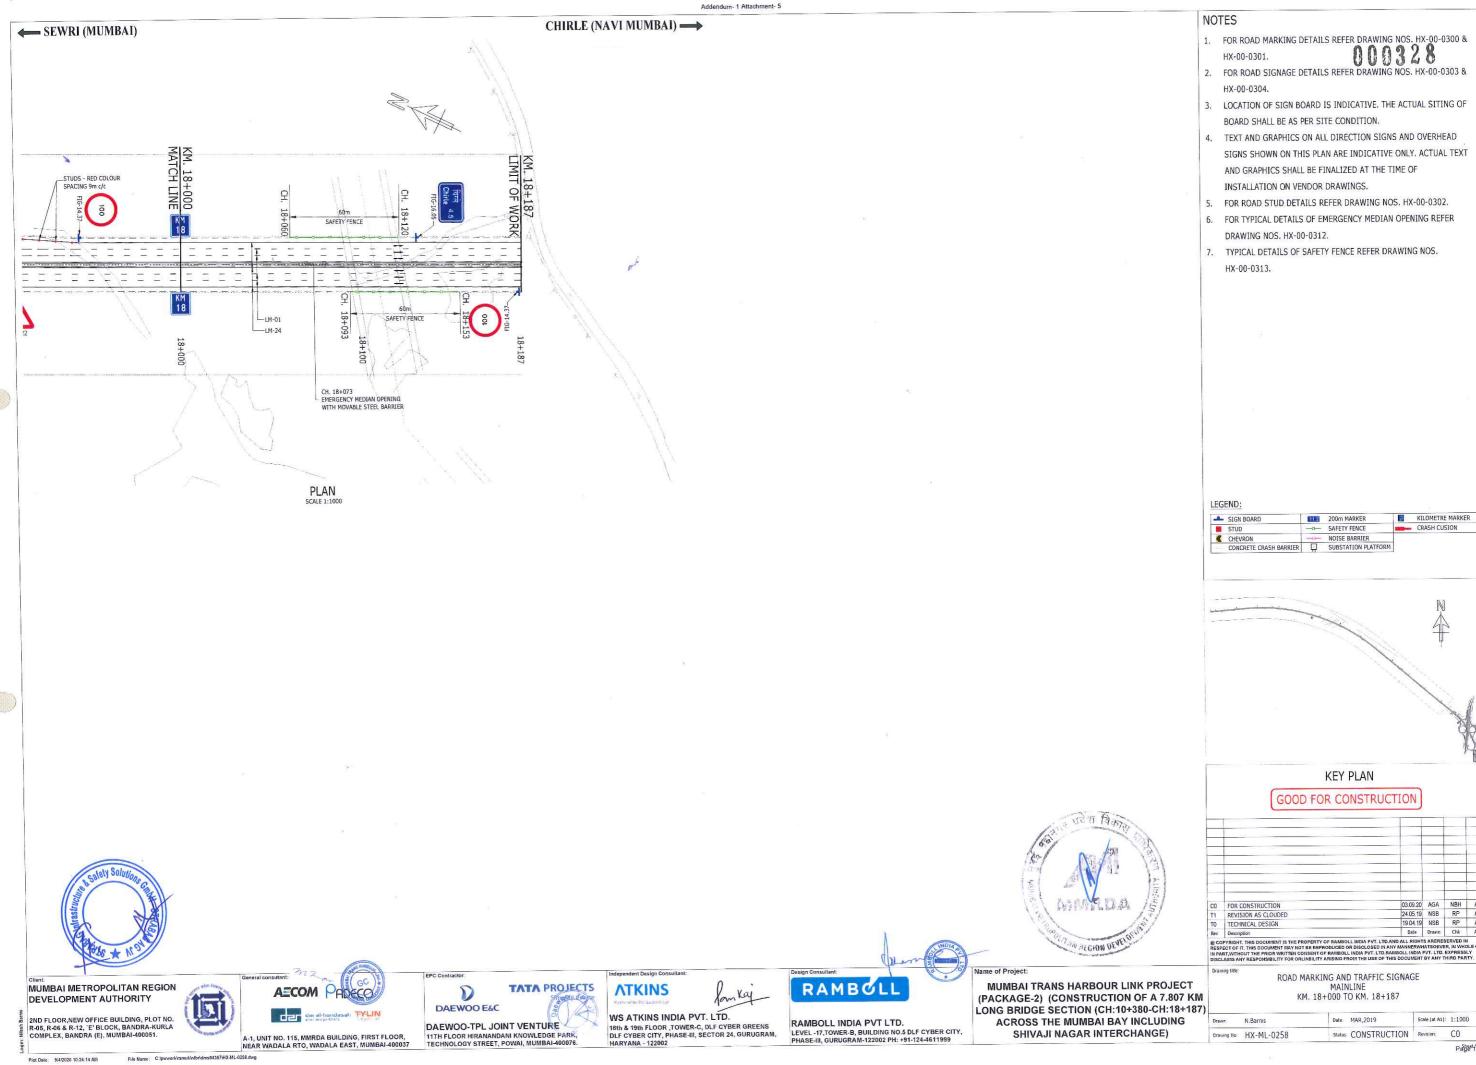MUMBAI METROPOLITAN REGION
DEVELOPMENT AUTHORITY

2ND FLOOR,NEW OFFICE BUILDING, PLOT NO. R-05, R-06 & R-12, "E" BLOCK, BANDRA-KURLA COMPLEX, BANDRA (E), MUMBAI-400051.



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A-1, UNIT NO. 115, MMRDA BUILDING, FIRST FLOOR, NEAR WADALA RTO, WADALA EAST, MUMBAI-400037 TATA PROJECTS

DAEWOO E&C

DAEWOO-TPL JOINT VENTURE
11TH FLOOR HIRANANDANI KNOWLEDGE PARK,
TECHNOLOGY STREET, POWAI, MUMBAI-400076.

Independent Design Consultant:

WS ATKINS INDIA PVT. LTD.

18th & 19th FLOOR, TOWER-C, DLF CYBER GREENS
DLF CYBER CITY, PHASE-III, SECTOR 24, GURUGRAM,

RAMBOLL RAMBOLL

RAMBOLL INDIA PVT LTD. LEVEL -17, TOWER-B, BUILDING NO.5 DLF CYBER CITY, PHASE-III, GURUGRAM-122002 PH: +91-124-4611999

Name of Project:

MUMBAI TRANS HARBOUR LINK PROJECT (PACKAGE-2) (CONSTRUCTION OF A 7.807 KM LONG BRIDGE SECTION (CH:10+380-CH:18+187) ACROSS THE MUMBAI BAY INCLUDING SHIVAJI NAGAR INTERCHANGE)


NOTES

- 1. FOR ROAD MARKING DETAILS REFER DRAWING NOS. HX-00-0300 & HX-00-0301.
- HX-00-0301.

 2. FOR ROAD SIGNAGE DETAILS REFER DRAWING BOS HX-00-0303 & HX-00-0304
- LOCATION OF SIGN BOARD IS INDICATIVE. THE ACTUAL SITING OF BOARD SHALL BE AS PER SITE CONDITION.
- 4. TEXT AND GRAPHICS ON ALL DIRECTION SIGNS AND OVERHEAD SIGNS SHOWN ON THIS PLAN ARE INDICATIVE ONLY, ACTUAL TEXT AND GRAPHICS SHALL BE FINALIZED AT THE TIME OF INSTALLATION ON VENDOR DRAWINGS.
- 5. FOR ROAD STUD DETAILS REFER DRAWING NOS. HX-00-0302.
- FOR FLEXIBLE BOLLARD AND IMPACT ATTENUATOR DETAILS REFER DRAWING NO. HX-00-0305.

LEGEND:

SIGN BOARD 200m MARKER KILOMETRE MARKER
STUD --- SAFETY FENCE CRASH CUSION
CHEVRON --- NOISE BARRIER
CONCRETE CRASH BARRIER SUBSTATION PLATFORM

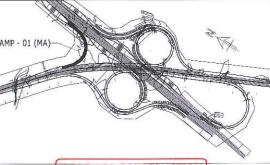

GOOD FOR CONSTRUCTION

1					
	FOR CONSTRUCTION	03.09.20	AGA	NBH	AS
-	REVISED AS PER GC COMMENTS	24.02.20	NSB	NBH	AS
	REVISION AS CLOUDED	24.05.19	NSB	RP	AS
	TECHNICAL DESIGN	19.04.19	NSB	RP	AS
	Description	Date	Drawn	Chk	Арр

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> ROAD MARKING & TRAFFIC SIGNAGE SHIVAJI NAGAR INTERCHANGE

RAMP-01 KM. 0+000 TO KM. 0+286.452

 Drawn
 N.Barnis
 Date
 MAR, 2019
 Scale (at A1)
 AS SHOWN

 Drawing III
 HX-SI-0250
 Status
 CONSTRUCTION
 Revision
 CO

Plot Date: 9/4/2020 10:37:53 AM

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← PROPOSED NAVI MUMBAI **AIRPORT**


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PLAN RAMP-02 SCALE 1:1000

NOTES MTHL (CHIRLE) →

- 1. FOR ROAD MARKING DETAILS REFER DRAWING NOS. HX-00-0300 & HX-00-0301.
- HX-00-0301.

 2. FOR ROAD SIGNAGE DETAILS REFERENCING NOSAX-00-0303 &
- 3. LOCATION OF SIGN BOARD IS INDICATIVE: THE ACTUAL SITING OF BOARD SHALL BE AS PER SITE CONDITION.
- 4. TEXT AND GRAPHICS ON ALL DIRECTION SIGNS AND OVERHEAD SIGNS SHOWN ON THIS PLAN ARE INDICATIVE ONLY. ACTUAL TEXT AND GRAPHICS SHALL BE FINALIZED AT THE TIME OF INSTALLATION ON VENDOR DRAWINGS.
- 5. FOR ROAD STUD DETAILS REFER DRAWING NOS. HX-00-0302.
- 6. FOR FLEXIBLE BOLLARD AND IMPACT ATTENUATOR DETAILS REFER DRAWING NO. HX-00-0305.

LEGEND:	UL.	.14	U.	

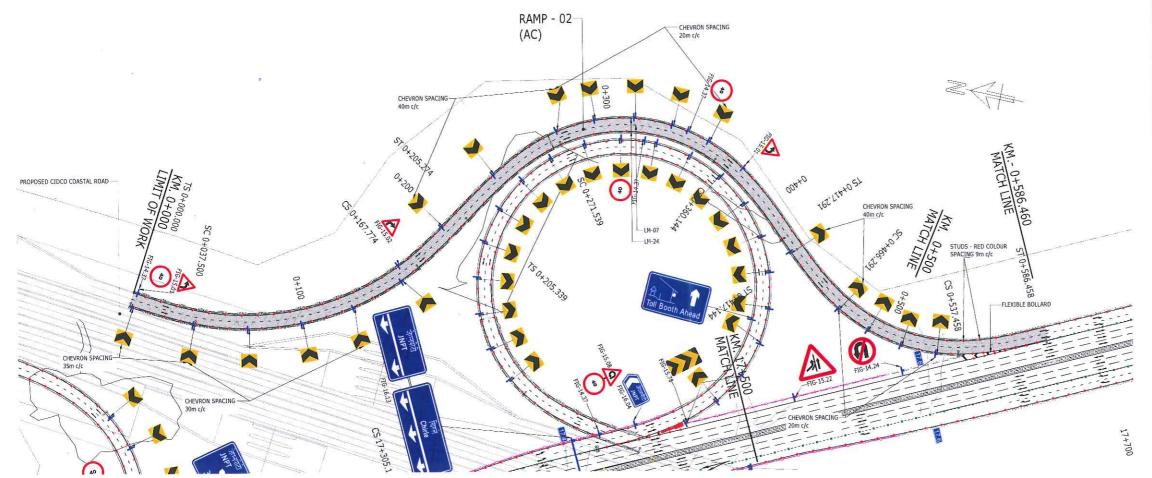•	SIGN BOARD	11.2	200m MARKER	32	KILOMETRE MARKER
	STUD	-0-	SAFETY FENCE	-	CRASH CUSION
4	CHEVRON	-0-	NOISE BARRIER		
1	CONCRETE CRASH BARRIER		SUBSTATION PLATFORM		



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	1			
FOR CONSTRUCTION	03.0	9.20 AGA	NBH	AS
REVISION AS CLOUDED	04.1	0.19 NSB	NBH	AS
REVISION AS CLOUDED	24.0	5.19 NSB	RP	AS
TECHNICAL DESIGN	19.0	4.19 NSB	RP	AS
Description	D	ate Drawn	Chk	Ap

ROAD MARKING & TRAFFIC SIGNAGE RAMP-02

Drawing No. HX-SI-0251

KM. 0+000 TO KM. 0+586.460 N.Barnis Date: MAR,2019 Scale (at A1): AS SHOWN

MUMBAI METROPOLITAN REGION DEVELOPMENT AUTHORITY

2ND FLOOR,NEW OFFICE BUILDING, PLOT NO. R-05, R-06 & R-12, 'E' BLOCK, BANDRA-KURLA COMPLEX, BANDRA (E), MUMBAI-400051.



DAEWOO-TPL JOINT VENTURE 11TH FLOOR HIRANANDANI KNOWLEDGE PARK, TECHNOLOGY STREET, POWAI, MUMBAI-400076.

D

DAEWOO E&C

TATA PROJECTS

ATKINS

WS ATKINS INDIA PVT. LTD.

18th & 19th FLOOR, TOWER-C, DLF CYBER GREENS
DLF CYBER CITY, PHASE-III, SECTOR 24, GURUGRAM, RAMBOLL INDIA PVT LTD.

RAMBOLL

MUMBAI TRANS HARBOUR LINK PROJECT (PACKAGE-2) (CONSTRUCTION OF A 7.807 KM LONG BRIDGE SECTION (CH:10+380-CH:18+187) ACROSS THE MUMBAI BAY INCLUDING SHIVAJI NAGAR INTERCHANGE)

A-1, UNIT NO. 115, MMRDA BUILDING, FIRST FLOOR, NEAR WADALA RTO, WADALA EAST, MUMBAI-400037

Addendum- 1 Attachment- 5 NOTES PROPOSED CIDCO COASTAL ROAD SEWRI (MUMBAI) 1. FOR ROAD MARKING DETAILS REFER DRAWING NOS. HX-00-0300 & HX-00-0304. 3. LOCATION OF SIGN BOARD IS INDICATIVE. THE ACTUAL SITING OF BOARD SHALL BE AS PER SITE CONDITION. 4. TEXT AND GRAPHICS ON ALL DIRECTION SIGNS AND OVERHEAD SIGNS SHOWN ON THIS PLAN ARE INDICATIVE ONLY. ACTUAL TEXT AND GRAPHICS SHALL BE FINALIZED AT THE TIME OF INSTALLATION 5. FOR ROAD STUD DETAILS REFER DRAWING NOS. HX-00-0302. 6. FOR FLEXIBLE BOLLARD AND IMPACT ATTENUATOR DETAILS REFER DRAWING NO. HX-00-0305. PROPOSED CIDCO COASTAL ROAD RAMP - 03 (MJ) LEGEND: C2 0+426'617 - SIGN BOARD KILOMETRE MARKER 200m MARKER - RAMP - 03 (MJ) KM. 0+529.930 LIMIT OF WORK CRASH CUSION FLEXIBLE BOLLARD PLAN RAMP-03 GOOD FOR CONSTRUCTION REVISED AS PER GC COMMENT REVISION AS CLOUDED MUMBAI METROPOLITAN REGION AECOM PAGECO MUMBAI TRANS HARBOUR LINK PROJECT TATA PROJECTS D **ATKINS** RAMBOLL SHIVAJI NAGAR INTERCHANGE RAMP-03 DEVELOPMENT AUTHORITY (PACKAGE-2) (CONSTRUCTION OF A 7.807 KM WS ATKINS INDIA PVT. LTB. DAEWOO E&C KM. 0+000 TO KM. 0+529.930 LONG BRIDGE SECTION (CH:10+380-CH:18+187) 2ND FLOOR,NEW OFFICE BUILDING, PLOT NO. R-05, R-06 & R-12, 'E' BLOCK, BANDRA-KURLA COMPLEX, BANDRA (E), MUMBAI-400051.

18th & 19th FLOOR, TOWER-C, DLF CYBER GREENS DLF CYBER CITY, PHASE-III, SECTOR 24, GURUGRAM, HARYANA - 122002

RAMBOLL INDIA PVT LTD.

LEVEL -17, TOWER-B, BUILDING NO.5 DLF CYBER CITY, PHASE-III, GURUGRAM-122002 PH: +91-124-4611999

DAEWOO-TPL JOINT VENTURE

(85)

Scale (at A1) AS SHOWN

ACROSS THE MUMBAI BAY INCLUDING


SHIVAJI NAGAR INTERCHANGE)

N.Barnis

Drawing No.: HX-S1-0252

Date: MAR, 2019


Status CONSTRUCTION Revision: CO

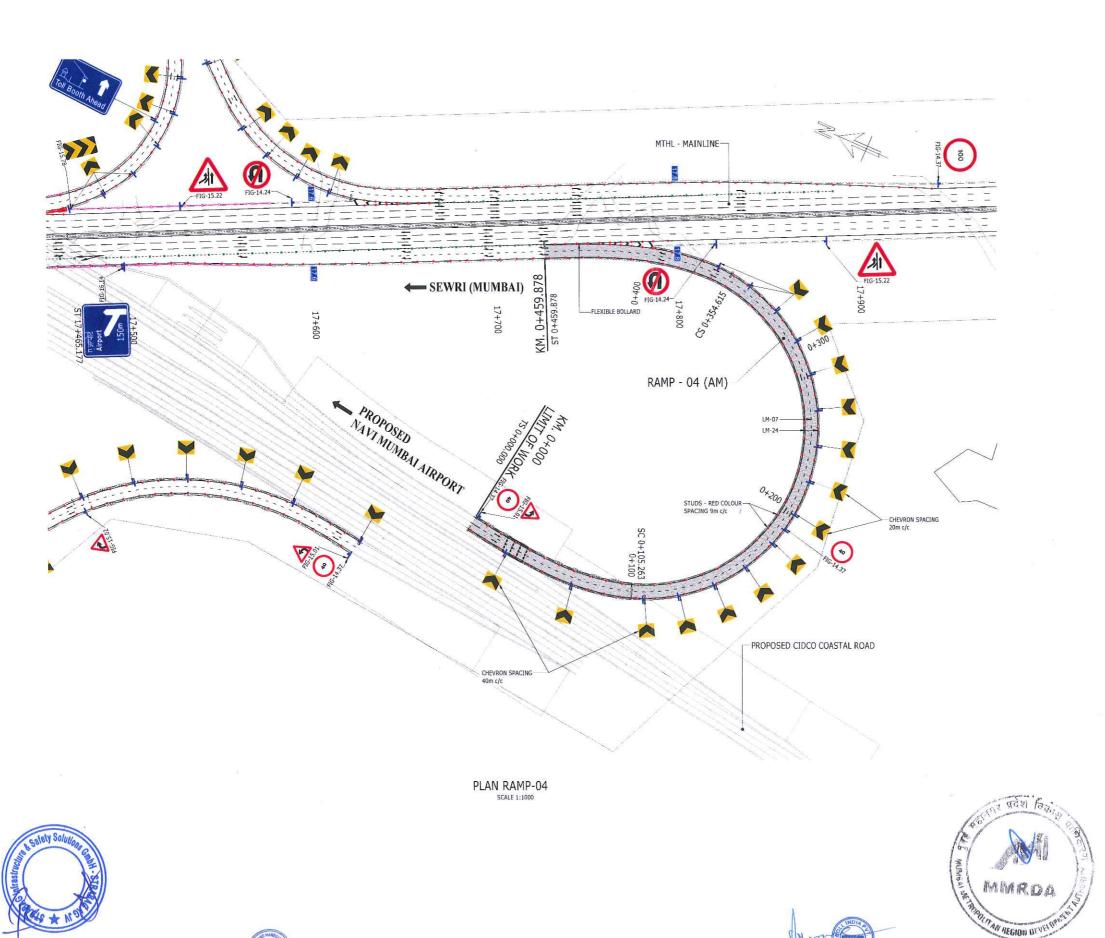

NOTES

- 1. FOR ROAD MARKING DETAILS REFER DRAWING NOS. HX-00-0300 & HX-00-0301.
- 1. FOR ROAD SIGNAGE DETAILS REPERTING IN 18541X-00-0303 & HX-00-0304.
- 3. LOCATION OF SIGN BOARD IS INDICATIVE. THE ACTUAL SITING OF BOARD SHALL BE AS PER SITE CONDITION.
- 4. TEXT AND GRAPHICS ON ALL DIRECTION SIGNS AND OVERHEAD SIGNS SHOWN ON THIS PLAN ARE INDICATIVE ONLY, ACTUAL TEXT AND GRAPHICS SHALL BE FINALIZED AT THE TIME OF INSTALLATION ON VENDOR DRAWINGS.
- 5. FOR ROAD STUD DETAILS REFER DRAWING NOS. HX-00-0302.
- 6. FOR FLEXIBLE BOLLARD AND IMPACT ATTENUATOR DETAILS REFER DRAWING NO. HX-00-0305.

CRASH CUSION

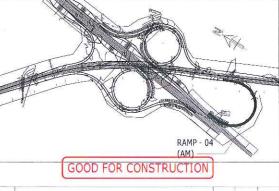

MUMBAI TRANS HARBOUR LINK PROJECT

(PACKAGE-2) (CONSTRUCTION OF A 7.807 KM

LONG BRIDGE SECTION (CH:10+380-CH:18+187)

ACROSS THE MUMBAI BAY INCLUDING

SHIVAJI NAGAR INTERCHANGE)

ROAD MARKING & TRAFFIC SIGNAGE SHIVAJI NAGAR INTERCHANGE RAMP-04 KM. 0+000 TO KM. 0+459.878

Drawn: N.Barnis Date MAR,2019 Scale (at AI.) AS SHOWN Drawing No. HX-SI-0253 Status CONSTRUCTION Revision CO

MUMBAI METROPOLITAN REGION DEVELOPMENT AUTHORITY

2ND FLOOR,NEW OFFICE BUILDING, PLOT NO. R-05, R-06 & R-12, 'E' BLOCK, BANDRA-KURLA COMPLEX, BANDRA (E), MUMBAI-400051.



A-1, UNIT NO. 115, MMRDA BUILDING, FIRST FLOOR, NEAR WADALA RTO, WADALA EAST, MUMBAI-400037

D DAEWOO E&C

TATA PROJECTS

DAEWOO-TPL JOINT VENTURE
11TH FLOOR HIRANANDANI KNOWLEDGE PARK,
TECHNOLOGY STREET, POWAI, MUMBAI-400076.



RAMBOLL INDIA PVT LTD. LEVEL -17, TOWER-B, BUILDING NO.5 DLF CYBER CITY, PHASE-III, GURUGRAM-122002 PH: +91-124-4611999

RAMBOLL

SEWRI (MUMBAI) **←** PROPOSED CIDCO COASTAL ROAD (JNPT) RAMP - 05 (JM) -CHEVRON SPACING 40m c/c _STUDS - RED COLOUR SPACING 9m c/c PROPOSED CIDCO COASTAL ROAD CHEVRON SPACING - MTHL - MAINLINE

PLAN RAMP-05

SCALE 1:1000


NOTES

- 1. FOR ROAD MARKING DETAILS REFER DRAWING NOS. HX-00-0300 &
- HX-00-0301.

 2. FOR ROAD SIGNAGE DETAILS REFER DRAWING NOSTHX-00-0303 & HX-00-0304.
- 3. LOCATION OF SIGN BOARD IS INDICATIVE. THE ACTUAL SITING OF BOARD SHALL BE AS PER SITE CONDITION.
- 4. TEXT AND GRAPHICS ON ALL DIRECTION SIGNS AND OVERHEAD SIGNS SHOWN ON THIS PLAN ARE INDICATIVE ONLY. ACTUAL TEXT AND GRAPHICS SHALL BE FINALIZED AT THE TIME OF INSTALLATION ON VENDOR DRAWINGS.
- 5. FOR ROAD STUD DETAILS REFER DRAWING NOS. HX-00-0302.
- 6. FOR FLEXIBLE BOLLARD AND IMPACT ATTENUATOR DETAILS REFER DRAWING NO. HX-00-0305.

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	SIGN BOARD	11.2	200m MARKER	17	KILOMETRE MARKER
	STUD	-0-	SAFETY FENCE		CRASH CUSION
«	CHEVRON	-0-	NOISE BARRIER		
1	CONCRETE CRASH BARRIER		SUBSTATION PLATFORM		

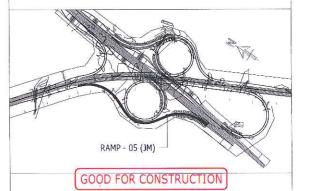

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				1	8
0	FOR CONSTRUCTION	03.09.20	AGA	NBH	AS
	REVISION AS CLOUDED	24.05.19	NSB	RP	AS
	TECHNICAL DESIGN	19.04.19	NSB	RP	AS
3	Description	Date	Drawn	Chk	App

ROAD MARKING & TRAFFIC SIGNAGE SHIVAJI NAGAR INTERCHANGE RAMP-05

KM. 0+000 TO KM. 0+638.259 Date MAR, 2019 N.Barnis Scale (at A1) AS SHOWN Drawing No. HX-SI-0254 Status: CONSTRUCTION Revision: CO

MUMBAI METROPOLITAN REGION DEVELOPMENT AUTHORITY

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(19)

2ND FLOOR,NEW OFFICE BUILDING, PLOT NO. R-05, R-06 & R-12, 'E' BLOCK, BANDRA-KURLA COMPLEX, BANDRA (E), MUMBAI-400051.



A-1, UNIT NO. 115, MMRDA BUILDING, FIRST FLOOR, NEAR WADALA RTO, WADALA EAST, MUMBAI-40003

D DAEWOO E&C

TATA PROJECTS

DAEWOO-TPL JOINT VENTURE
11TH FLOOR HIRANANDANI KNOWLEDGE PARK,
TECHNOLOGY STREET, POWAI, MUMBAI-400076.

WS ATKINS INDIA PVT. LTD.

18th & 19th FLOOR, TOWER-C, DLF CYBER GREENS
DLF CYBER CITY, PHASE-III, SECTOR 24, GURUGRAM,

ATKINS

RAMBOLL INDIA PVT LTD. LEVEL -17, TOWER-B, BUILDING NO.5 DLF CYBER CITY, PHASE-III, GURUGRAM-122002 PH: +91-124-4611999

RAMBOLL

(PACKAGE-2) (CONSTRUCTION OF A 7.807 KM LONG BRIDGE SECTION (CH:10+380-CH:18+187) ACROSS THE MUMBAI BAY INCLUDING SHIVAJI NAGAR INTERCHANGE)

MUMBAI TRANS HARBOUR LINK PROJECT

PROPOSED NAVI MUMBAI - NOTES AIRPORT

- 1. FOR ROAD MARKING DETAILS REFER DRAWING NOS. HX-00-0300 &
- 2. FOR ROAD SIGNAGE DETAILS RELER DRAWING NOS AX-00-0303 & HX-00-0304.
- 3. LOCATION OF SIGN BOARD IS INDICATIVE. THE ACTUAL SITING OF BOARD SHALL BE AS PER SITE CONDITION.
- 4. TEXT AND GRAPHICS ON ALL DIRECTION SIGNS AND OVERHEAD SIGNS SHOWN ON THIS PLAN ARE INDICATIVE ONLY. ACTUAL TEXT AND GRAPHICS SHALL BE FINALIZED AT THE TIME OF INSTALLATION ON VENDOR DRAWINGS.
- 5. FOR ROAD STUD DETAILS REFER DRAWING NOS. HX-00-0302.
- 6. FOR FLEXIBLE BOLLARD AND IMPACT ATTENUATOR DETAILS REFER DRAWING NO. HX-00-0305.

LEGEND:

-	SIGN BOARD	11.2	200m MARKER	37	KILOMETRE MARKER
	STUD	-0-	SAFETY FENCE	1000	CRASH CUSION
4	CHEVRON	-0-	NOISE BARRIER		
	CONCRETE CRASH BARRIER		SUBSTATION PLATFORM		



GOOD FOR CONSTRUCTION

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CO	FOR CONSTRUCTION	03,09.20	AGA	NBH	AS
T3	REVISED AS PER GC COMMENTS	24.02.20	NSB	NBH	AS
T2	REVISION AS CLOUDED	04.10.19	NSB	NBH	AS
T1	REVISION AS CLOUDED	24.05.19	NSB	RP	AS
TO:	TECHNICAL DESIGN	19.04.19	NSB	RP	AS
Rev	Description	Date	Drawn	Chk	Арр

ROAD MARKING & TRAFFIC SIGNAGE SHIVAJI NAGAR INTERCHANGE RAMP-06

KM. 0+000 TO KM. 0+560.676 Date MAR,2019 N.Barnis Scale (at A1). AS SHOWN Status CONSTRUCTION Revision CO Drawing No HX-SI-0255

-CRASH CUSION -FLEXIBLE BOLLARD KM. 0+560.676 LIMIT OF WORK KM. 0+000 PROPOSED CIDCO COASTAL ROAD COLOUR SPACING 9m c/c

> PLAN RAMP-06 SCALE 1;1000

> > **ATKINS**



MUMBAI METROPOLITAN REGION DEVELOPMENT AUTHORITY

(

2ND FLOOR,NEW OFFICE BUILDING, PLOT NO. R-05, R-06 & R-12, "E" BLOCK, BANDRA-KURLA COMPLEX, BANDRA (E), MUMBAI-400051.



D DAEWOO E&C

TATA PROJECTS DAEWOO-TPL JOINT VENTURE
11TH FLOOR HIRANANDANI KNOWLEDGE PARK,
TECHNOLOGY STREET, POWAI, MUMBAI-400076.



RAMBOLL INDIA PVT LTD.


RAMBOLL

MUMBAI TRANS HARBOUR LINK PROJECT (PACKAGE-2) (CONSTRUCTION OF A 7.807 KM LONG BRIDGE SECTION (CH:10+380-CH:18+187) ACROSS THE MUMBAI BAY INCLUDING


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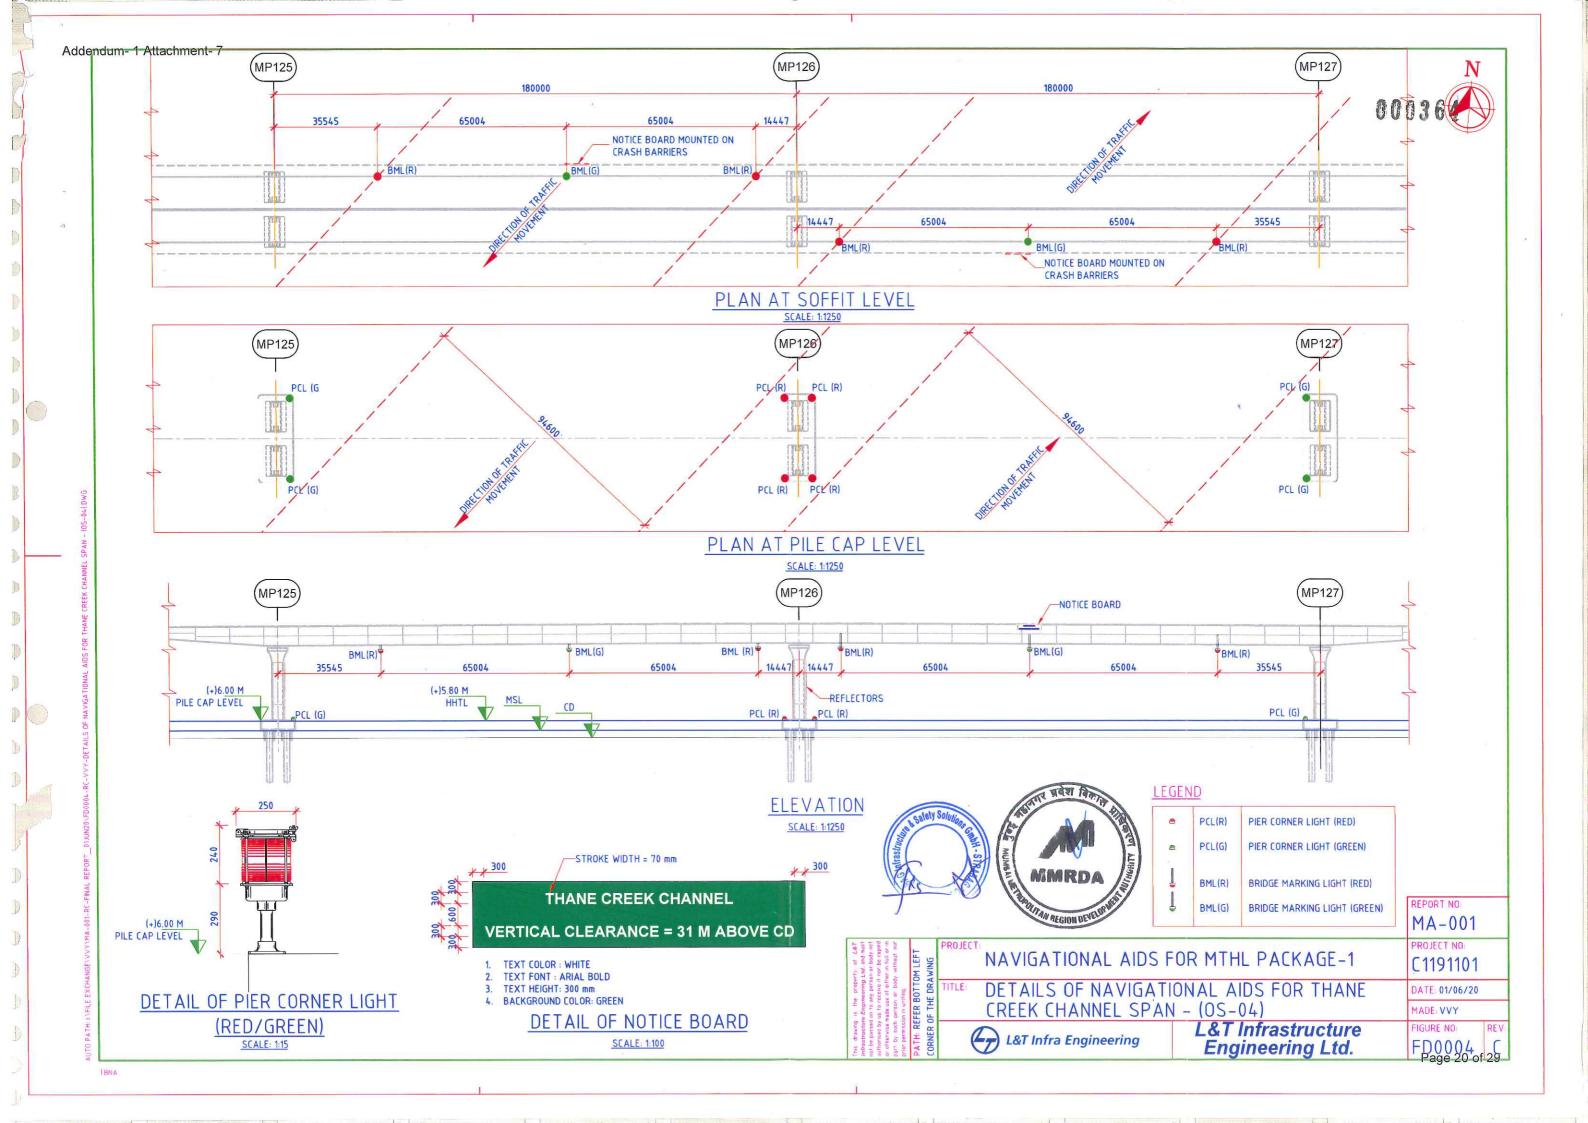
SHIVAJI NAGAR INTERCHANGE)


LEVEL -17,TOWER-B, BUILDING NO.5 DLF CYBER CITY, PHASE-III, GURUGRAM-122002 PH: +91-124-4611999

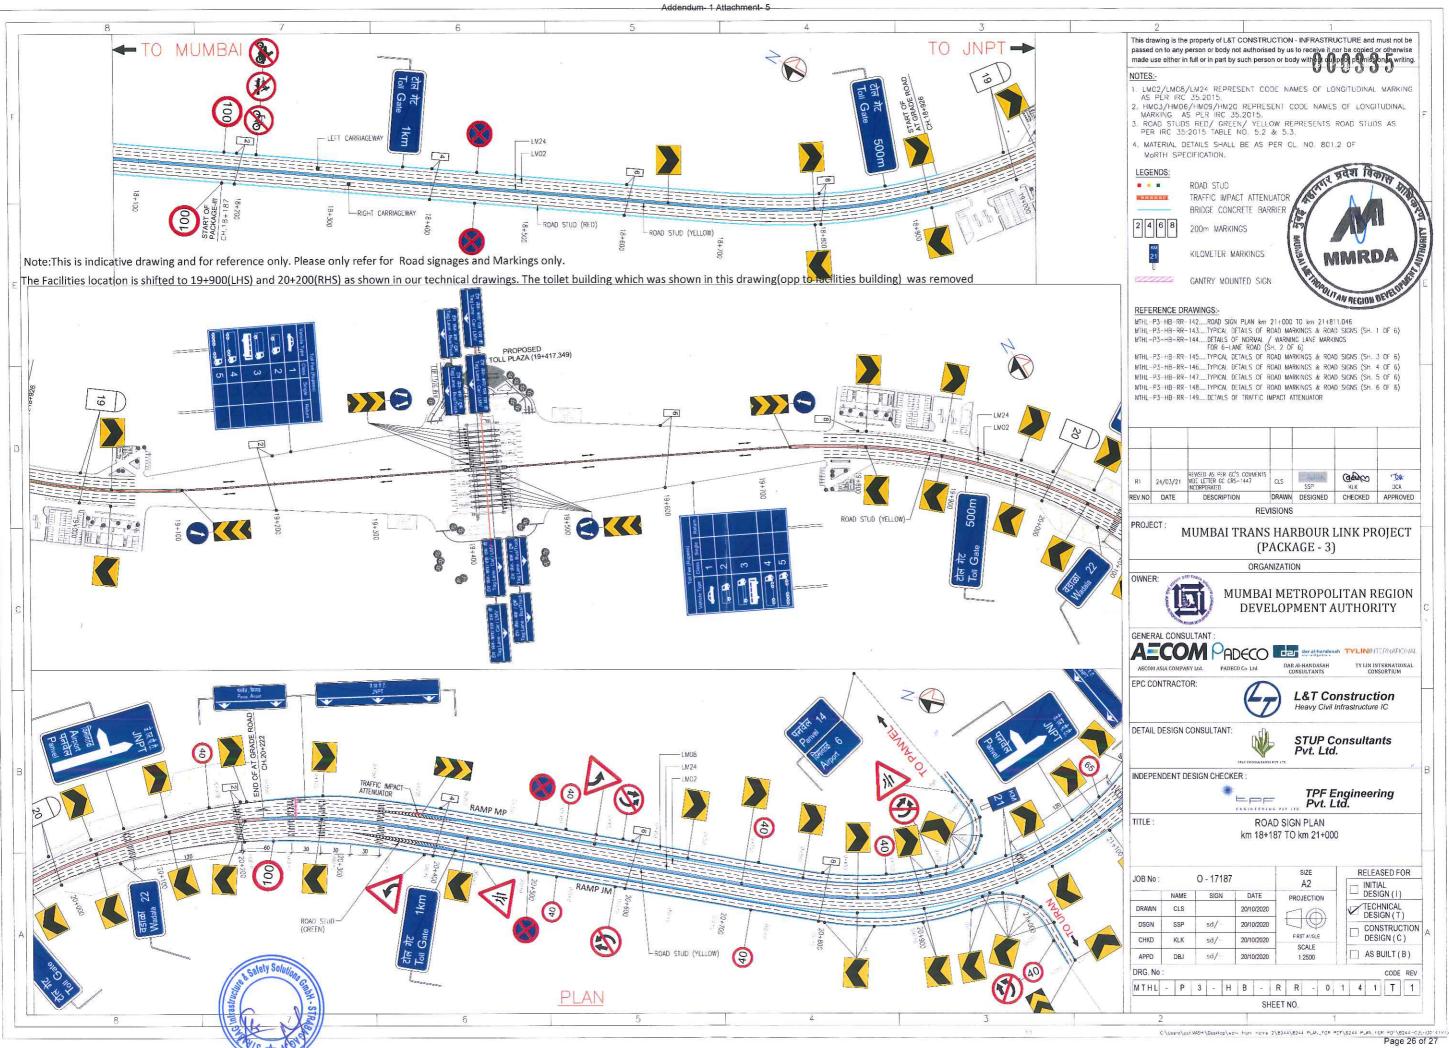



(6)



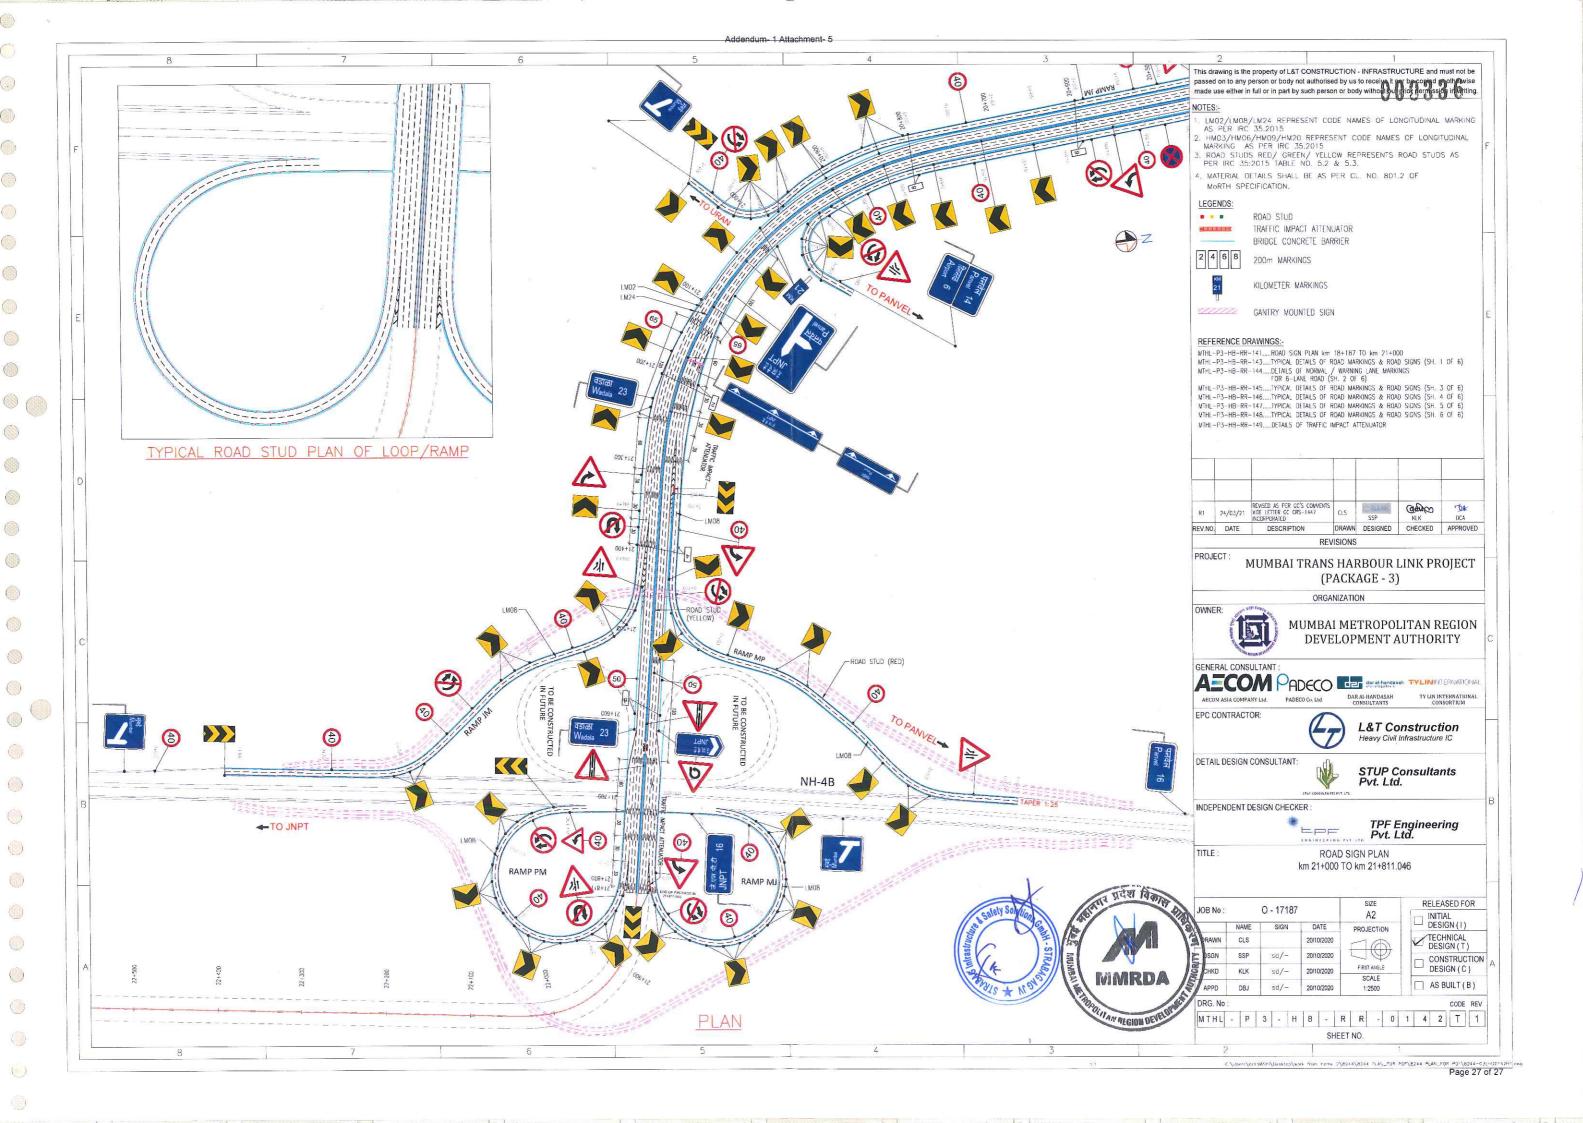


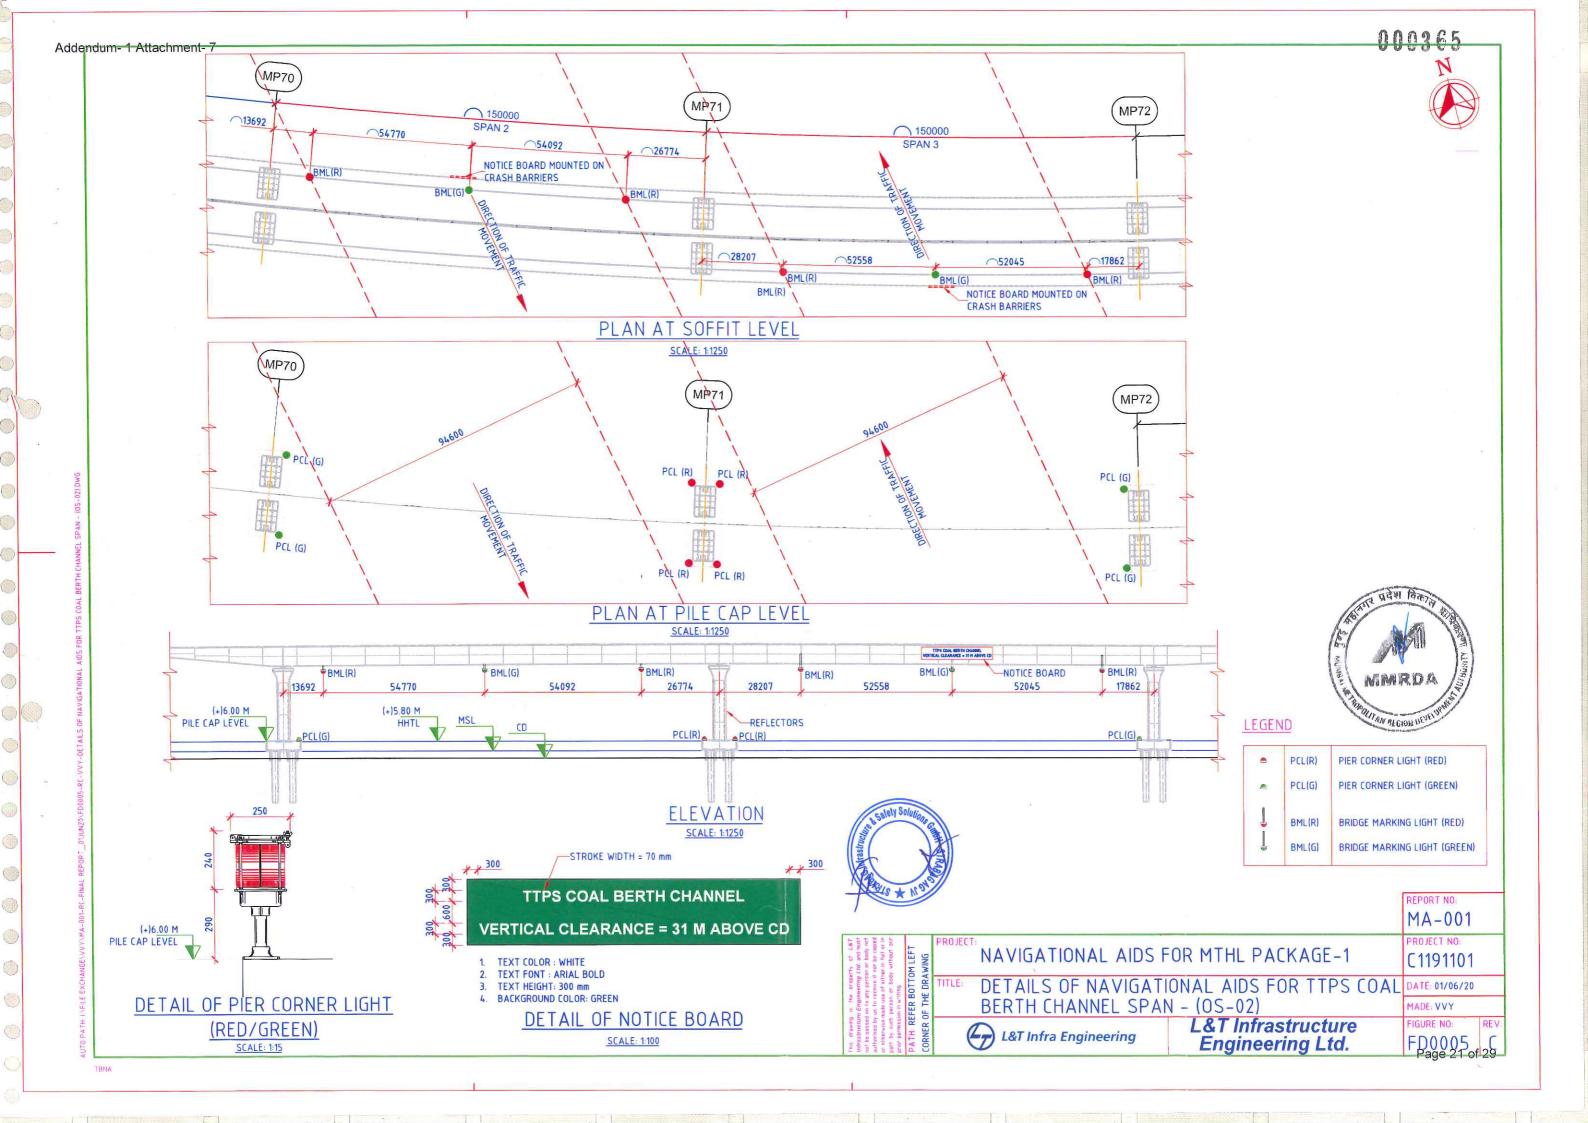


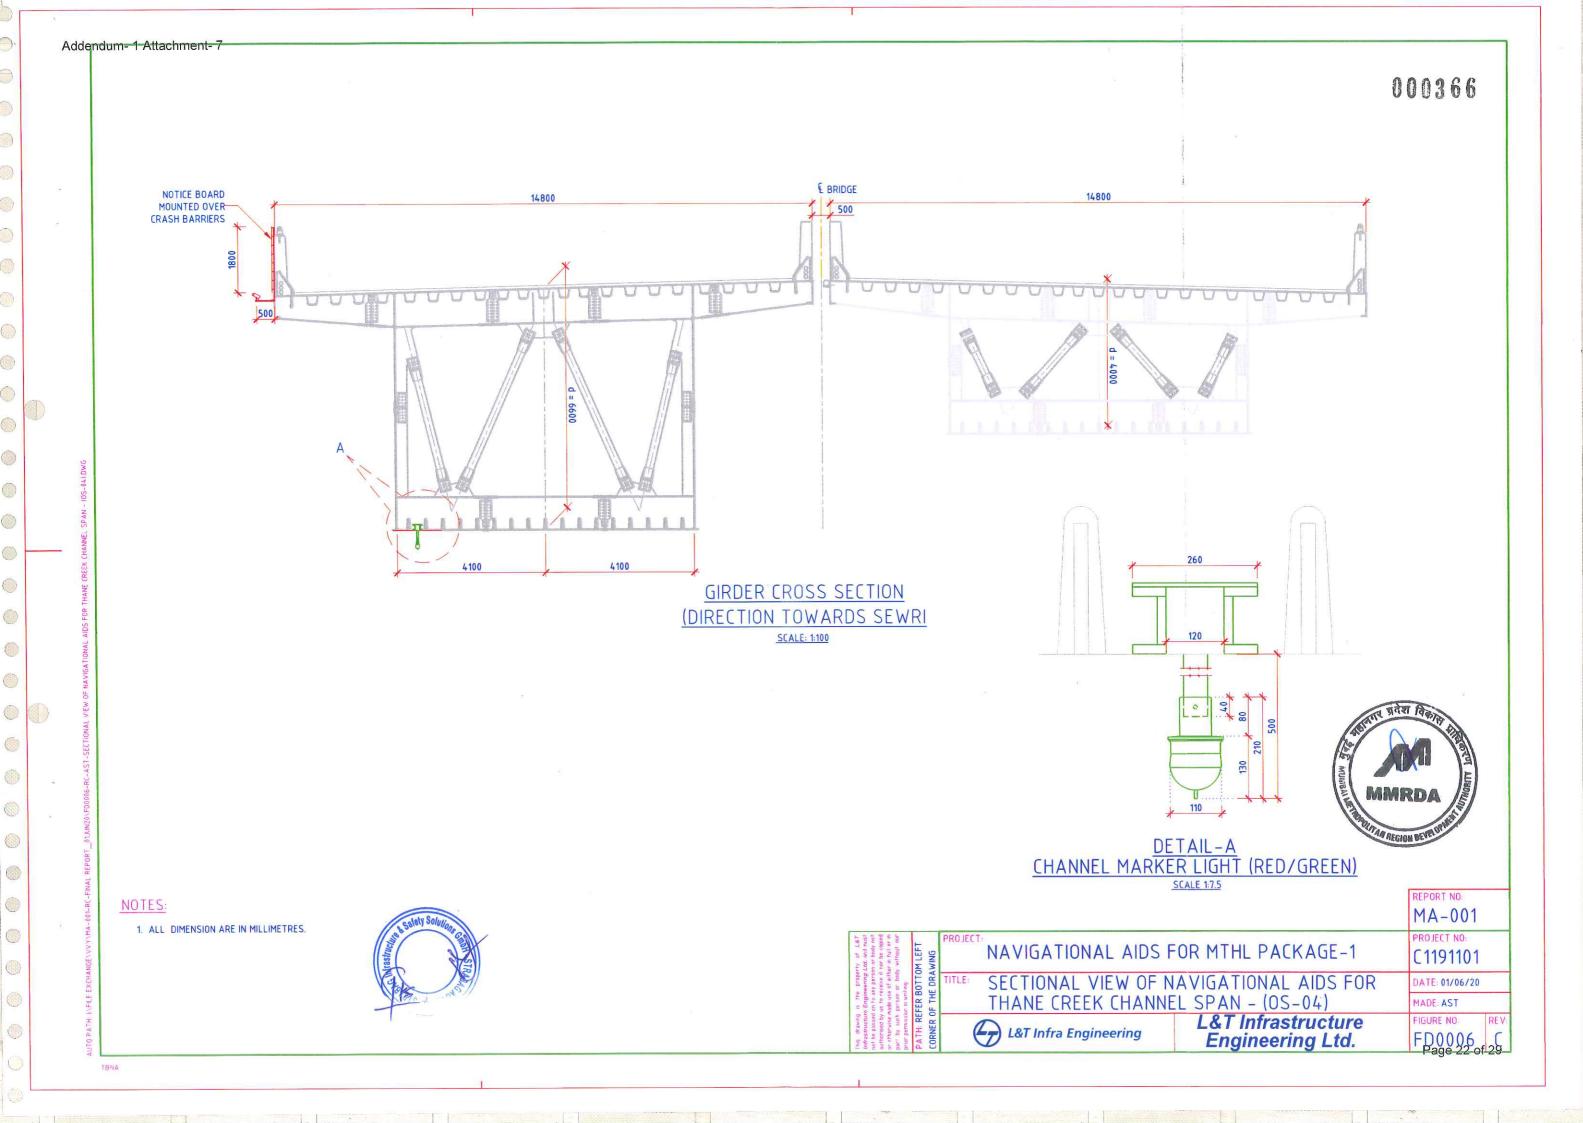


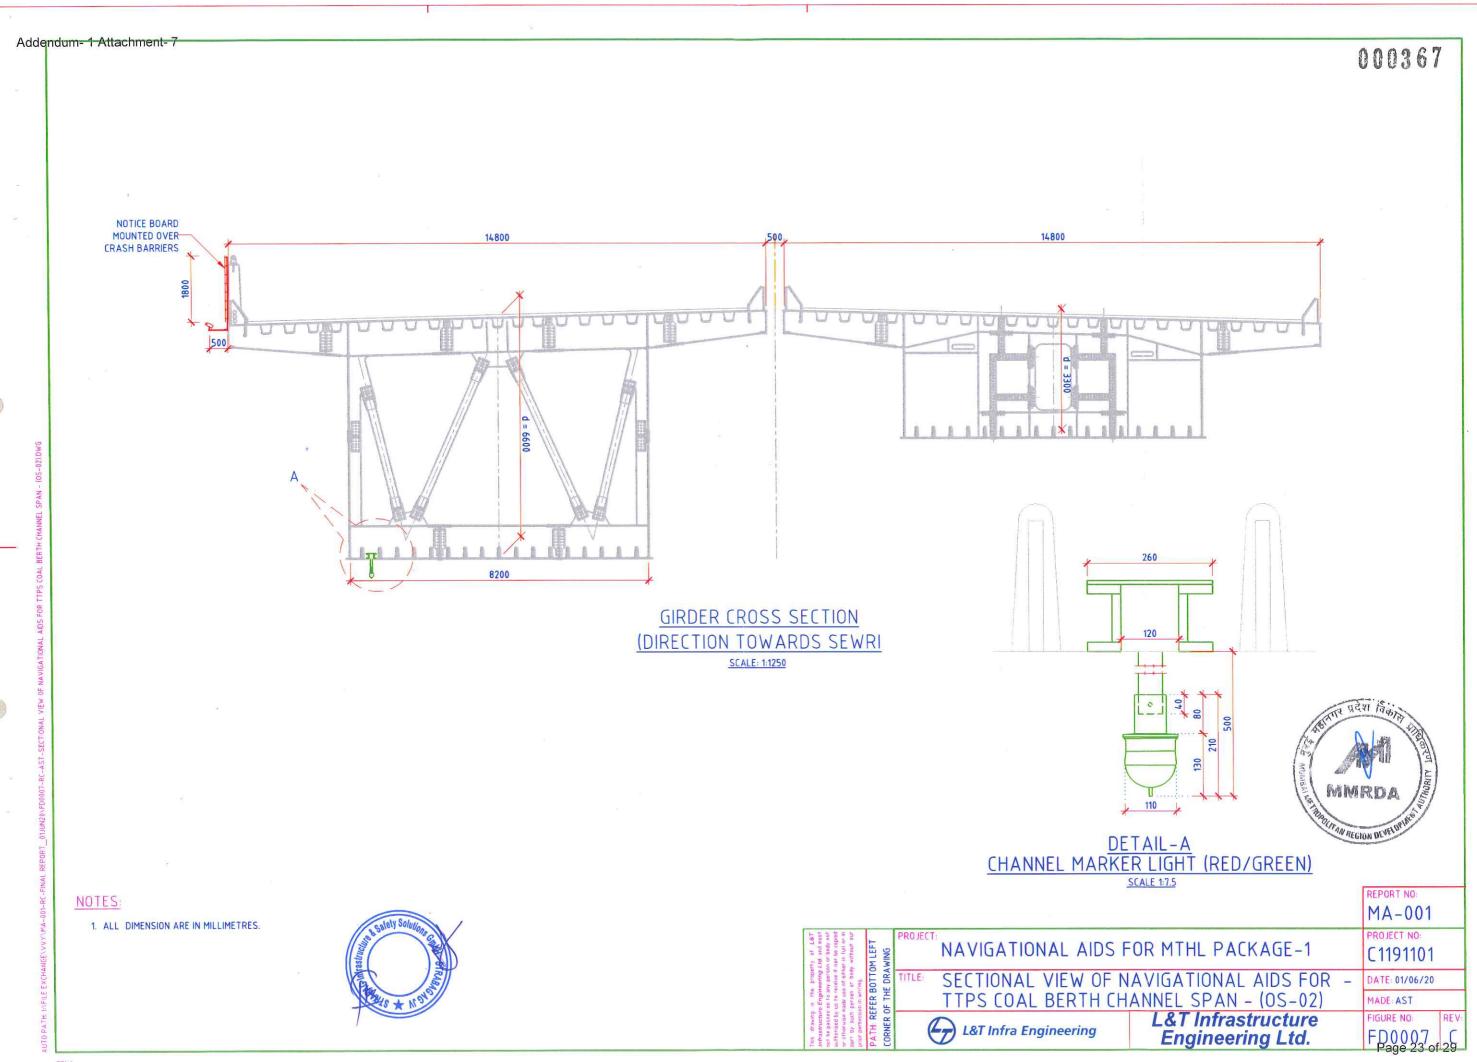



TENA

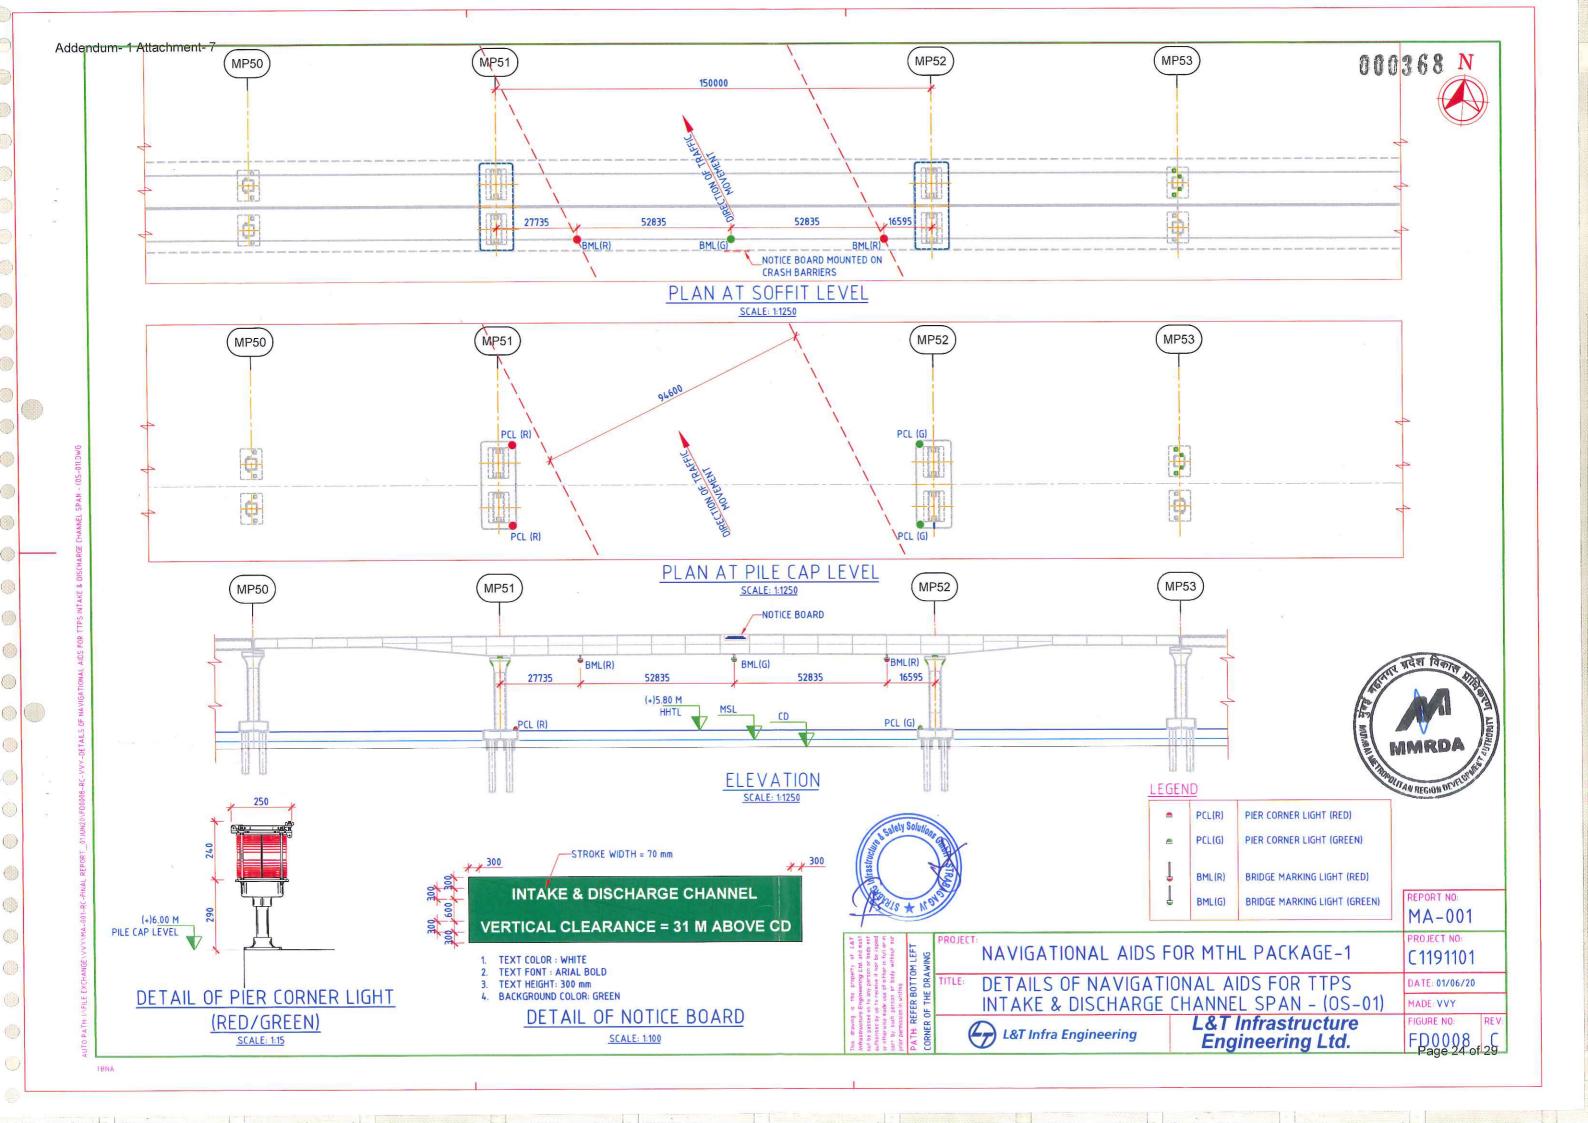

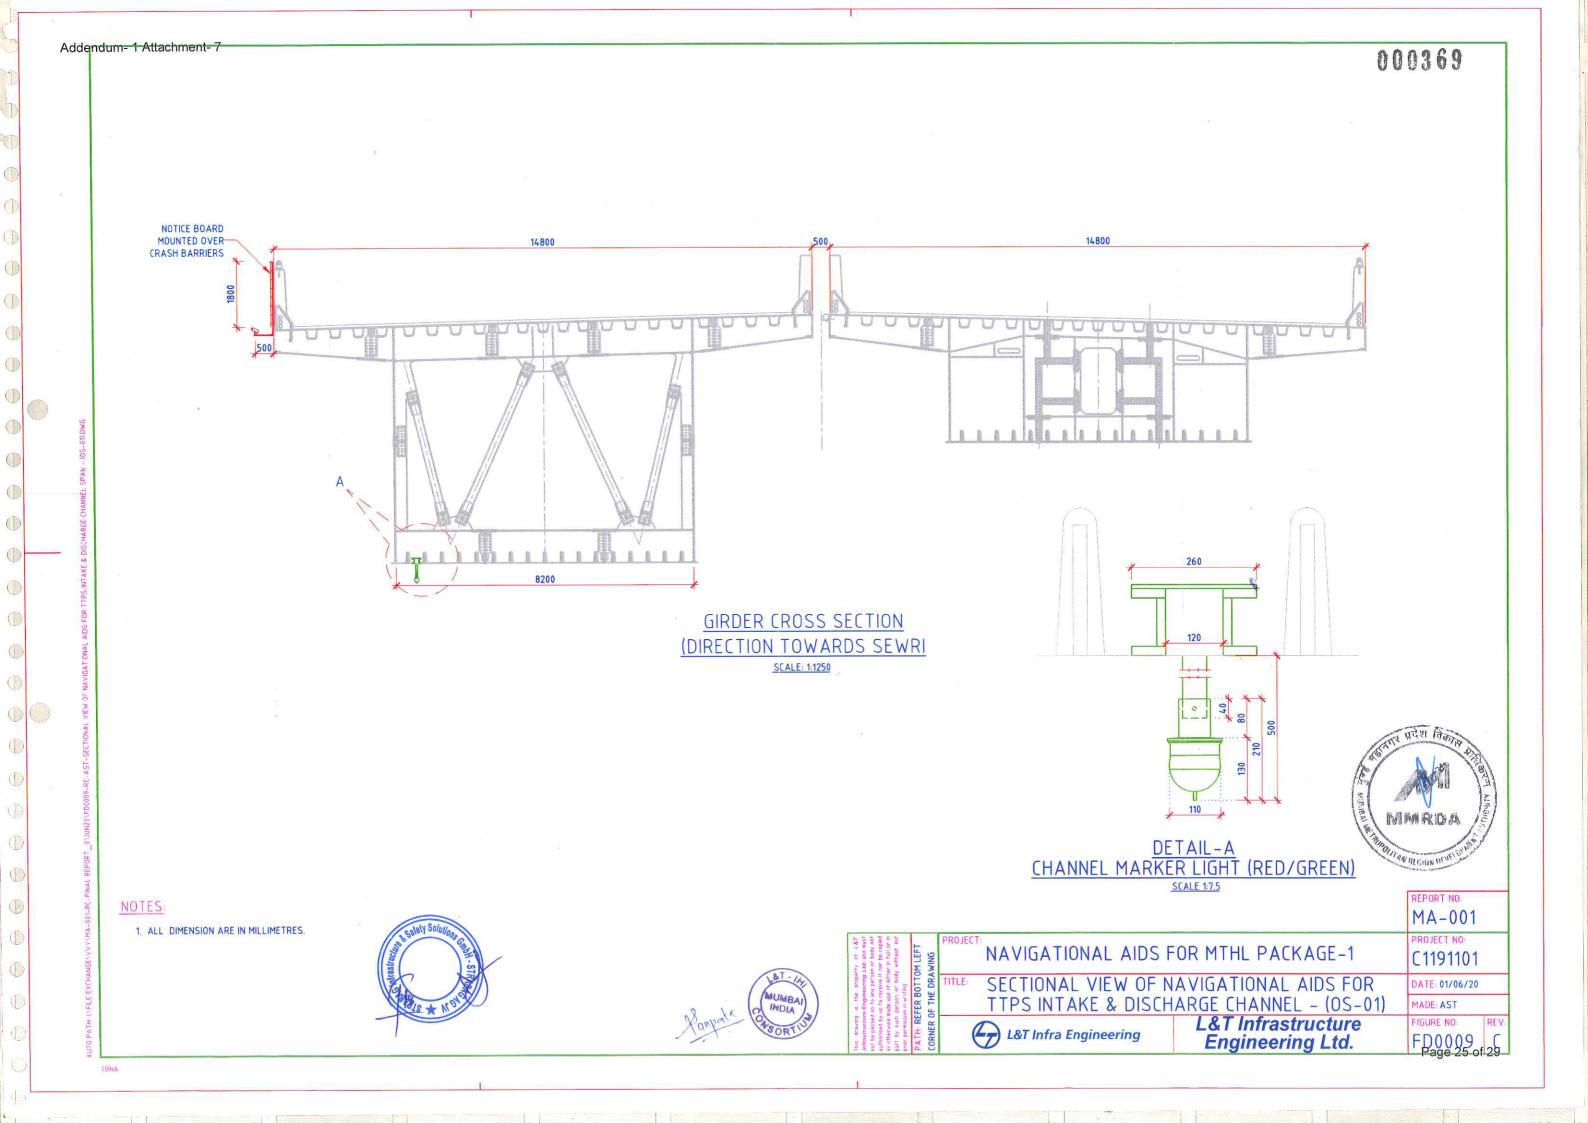


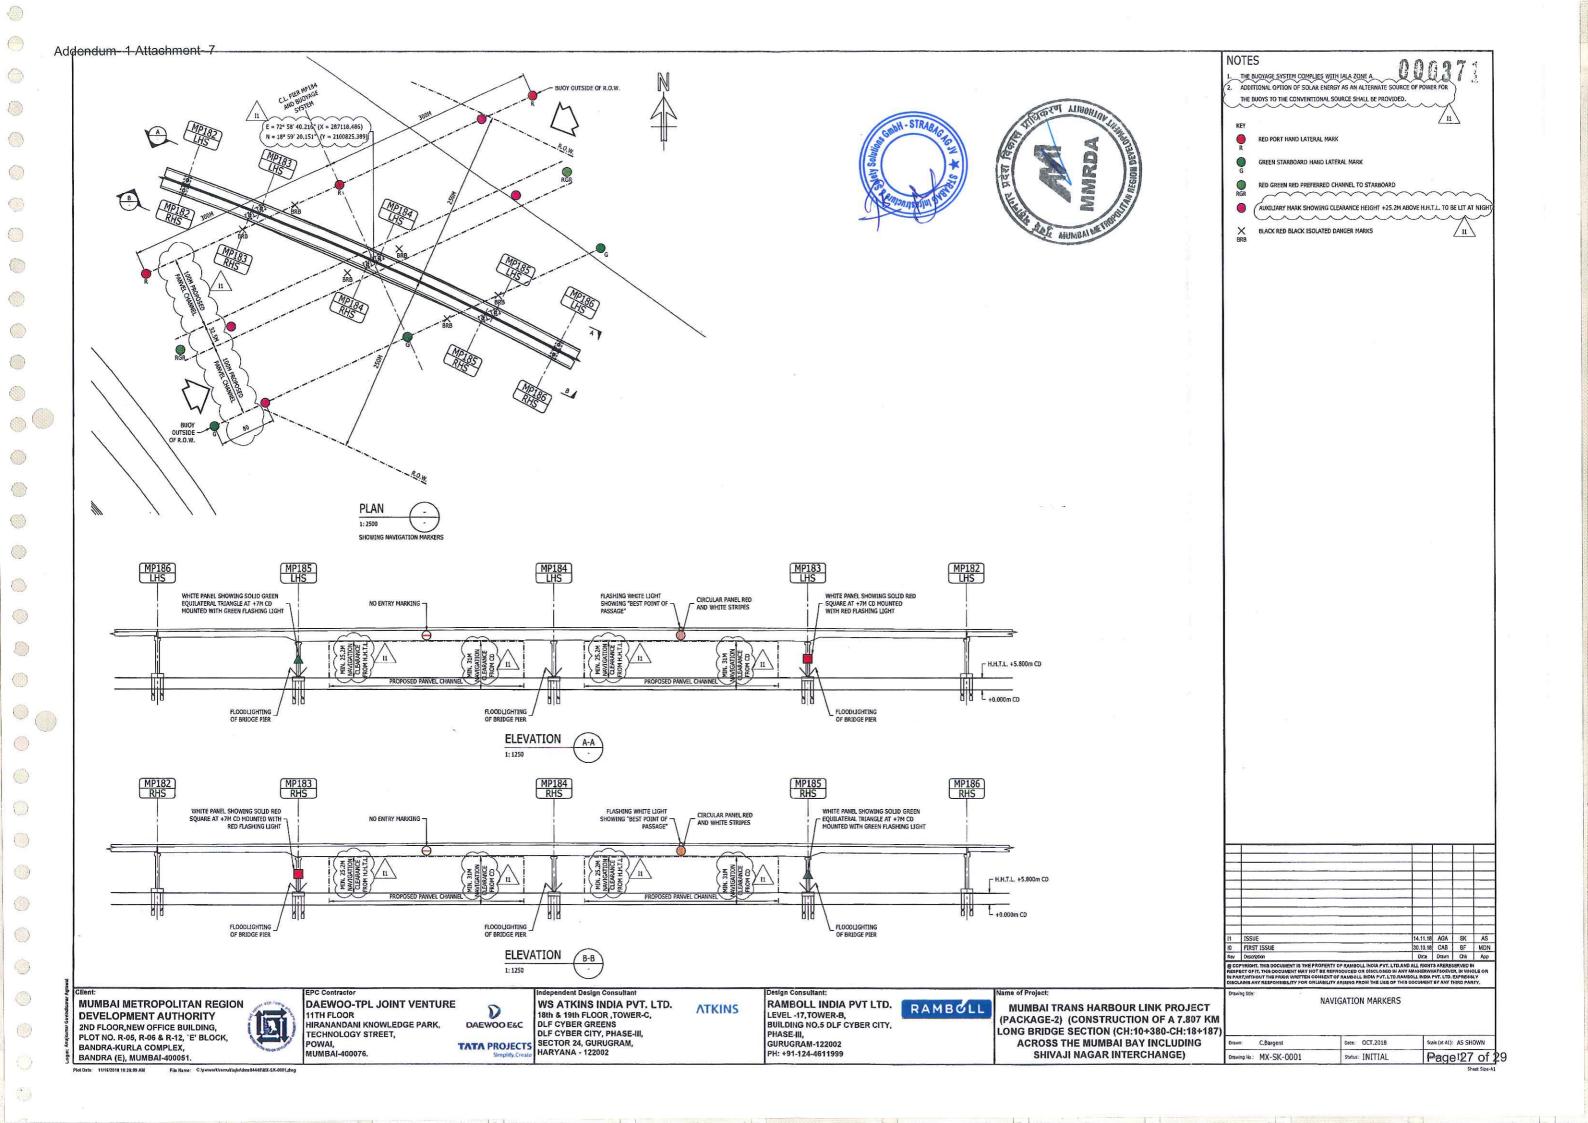


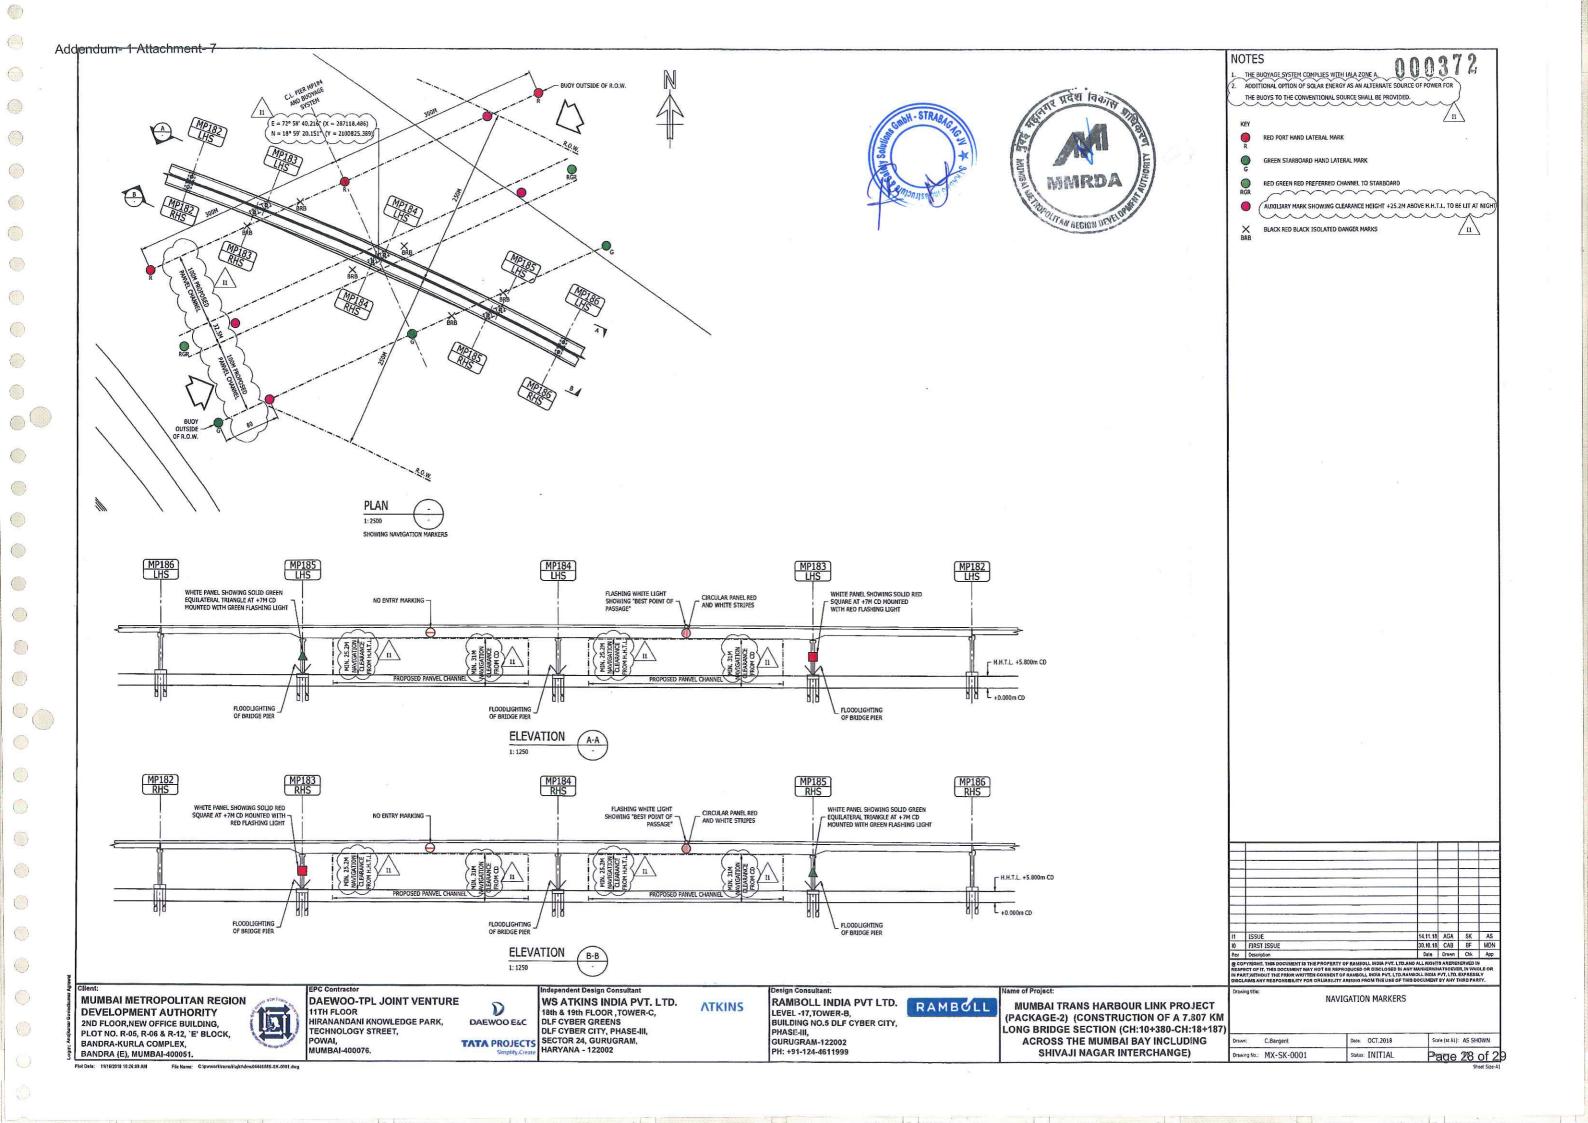


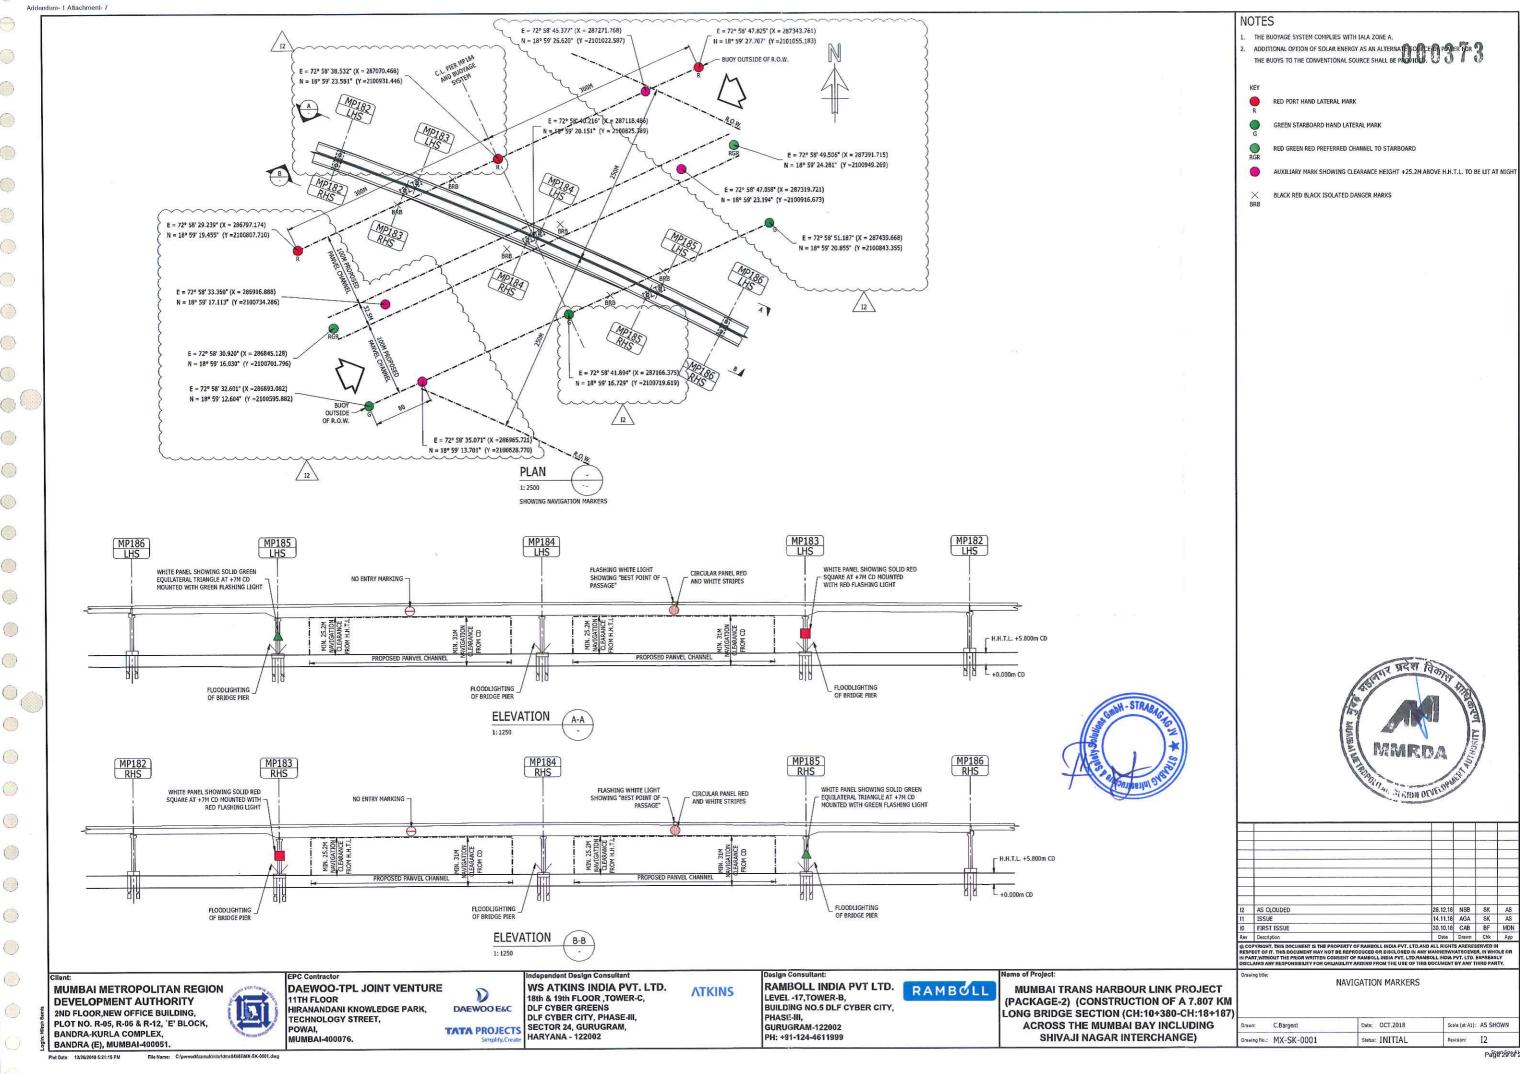


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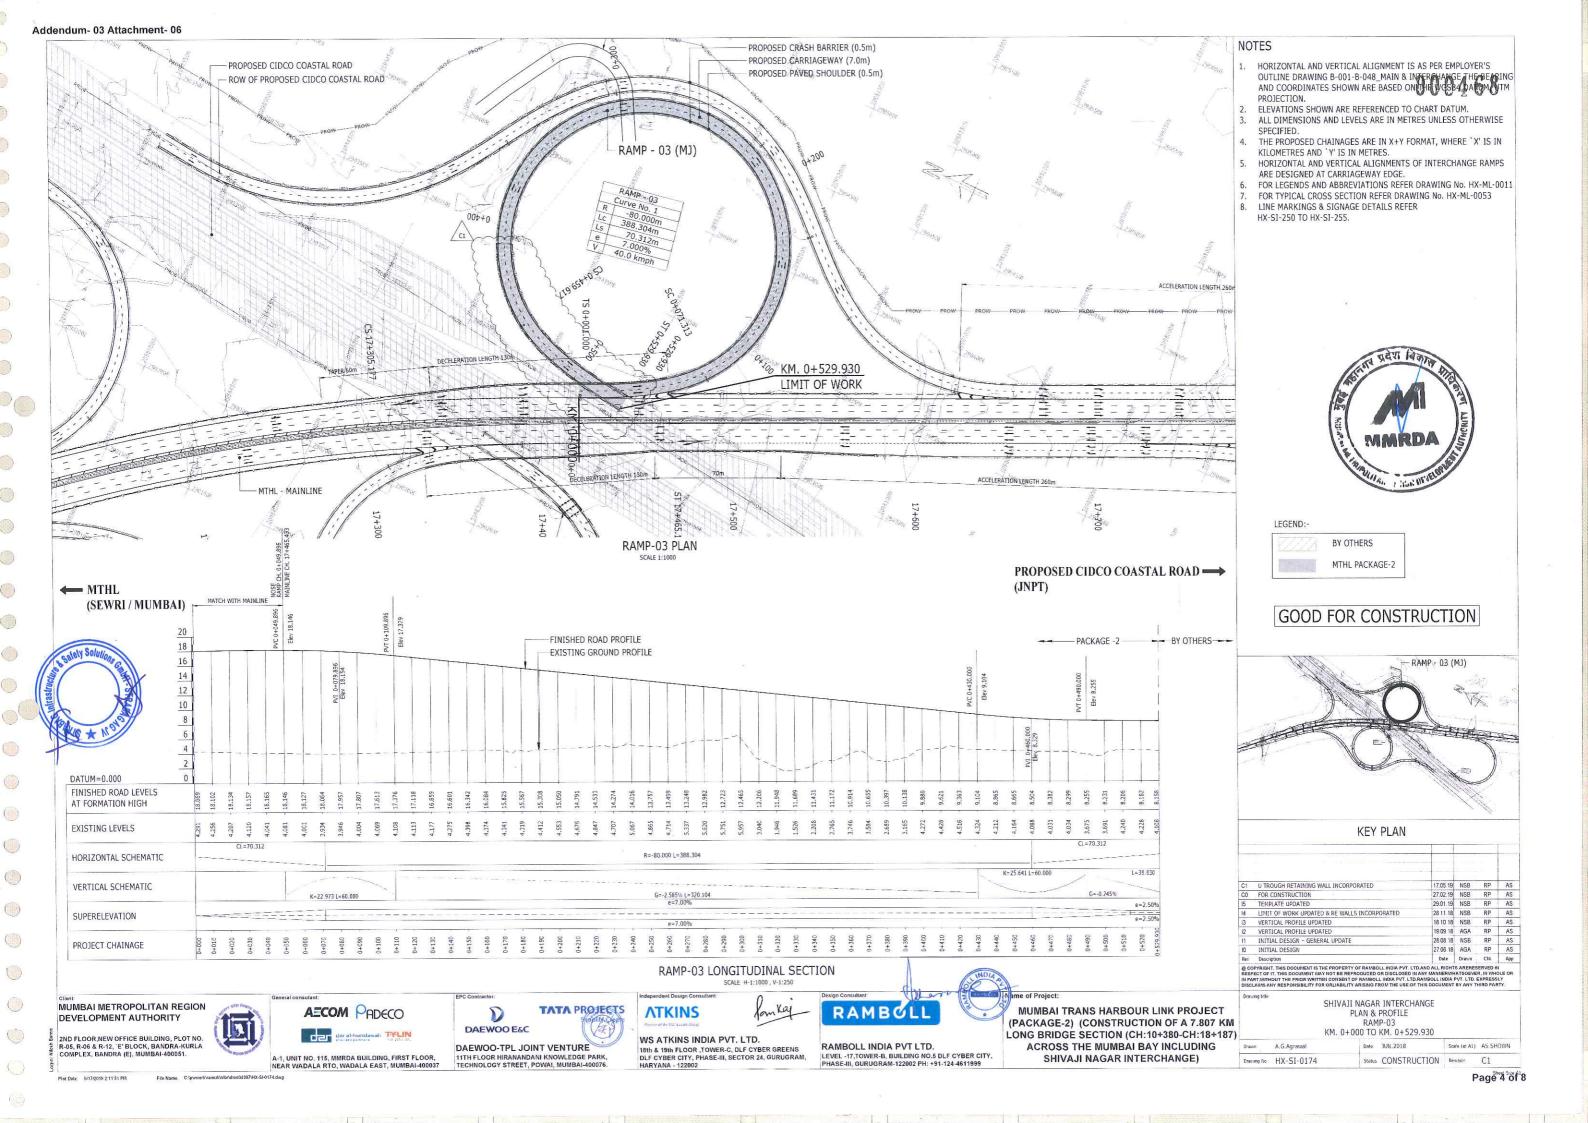


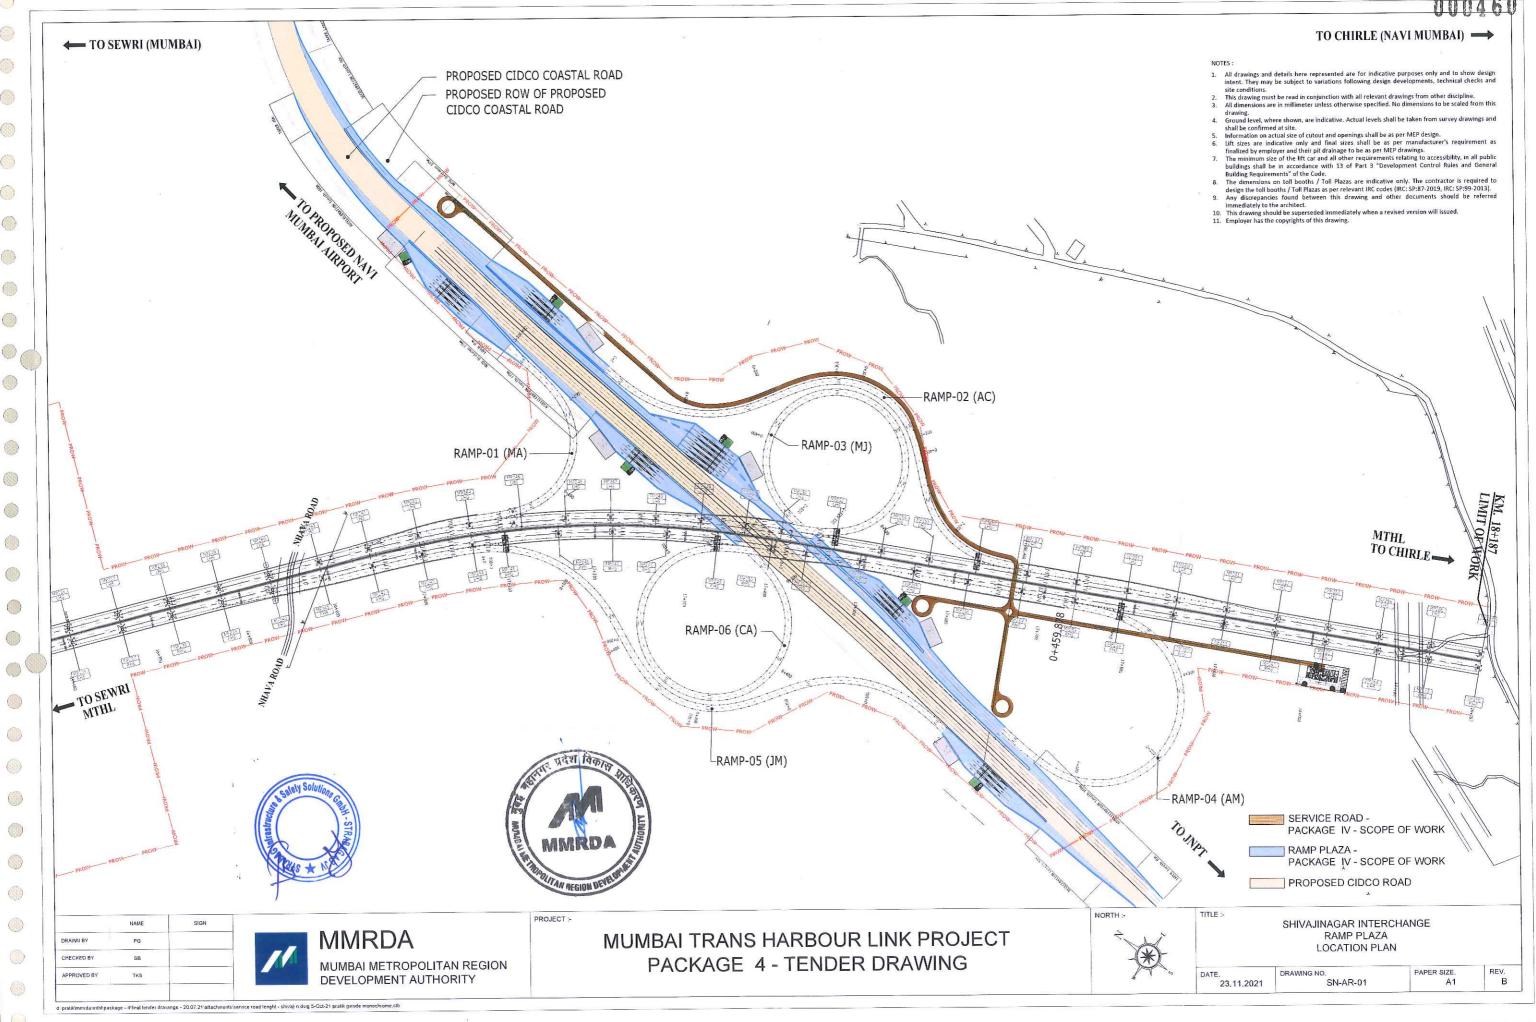


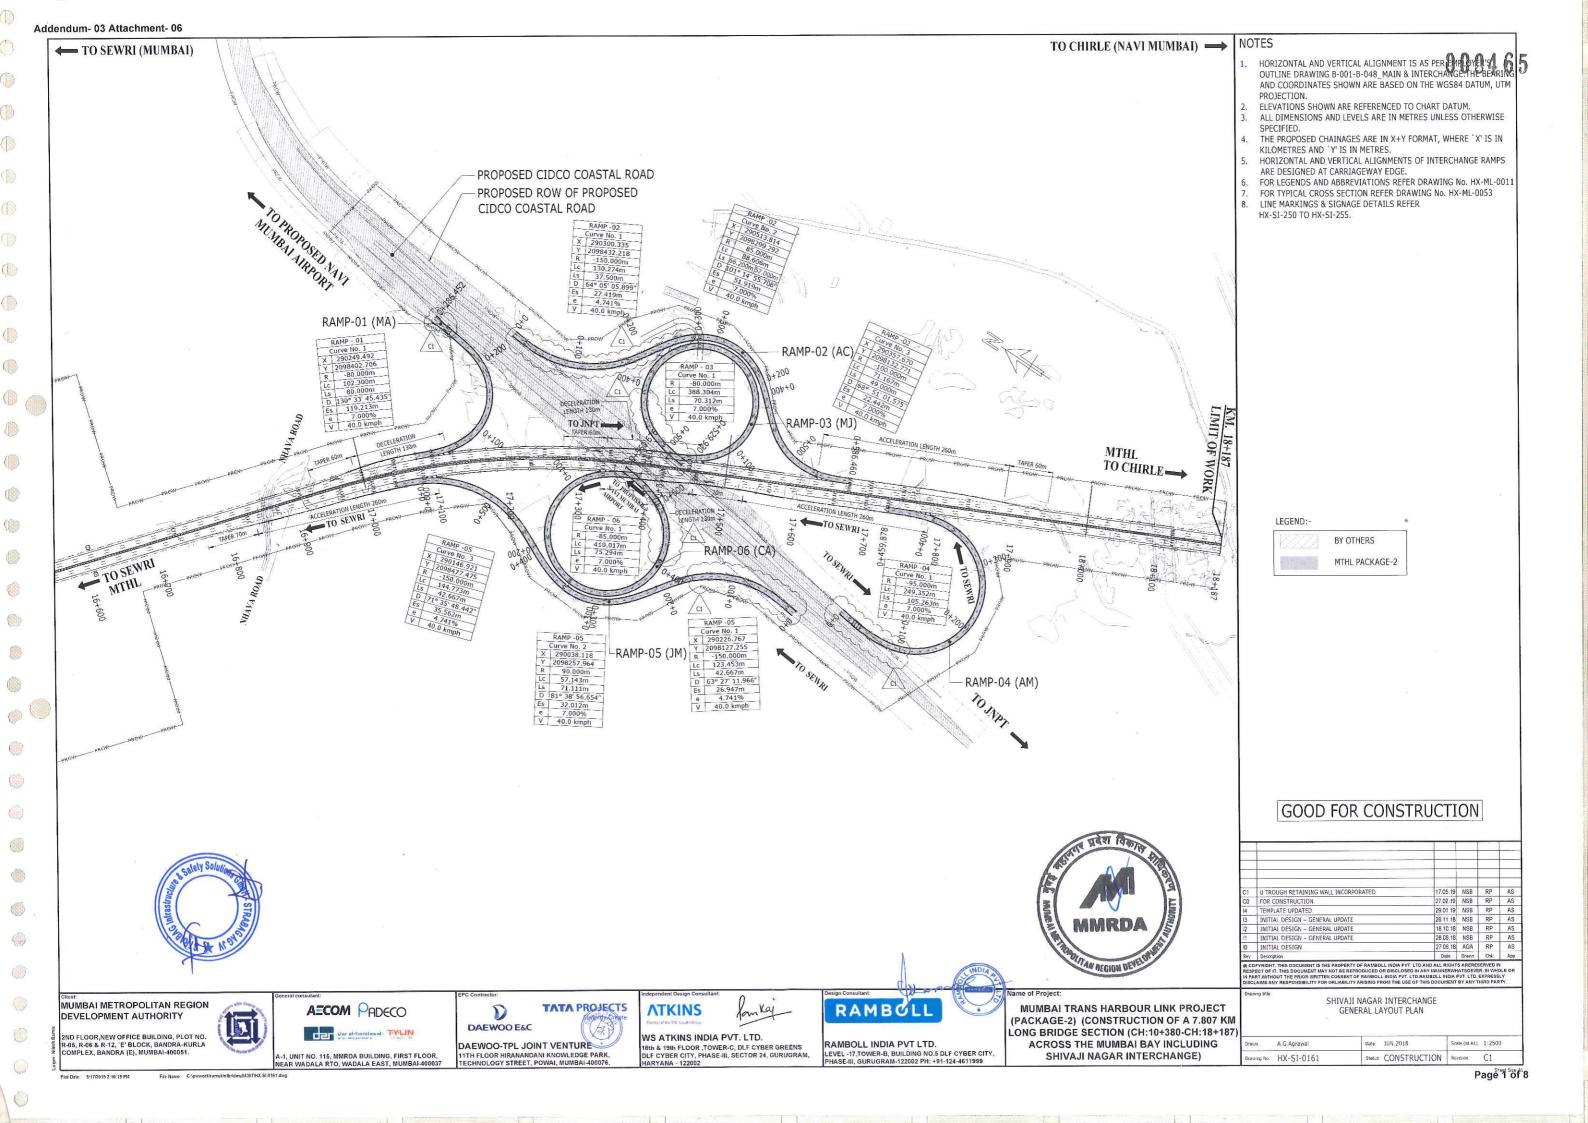


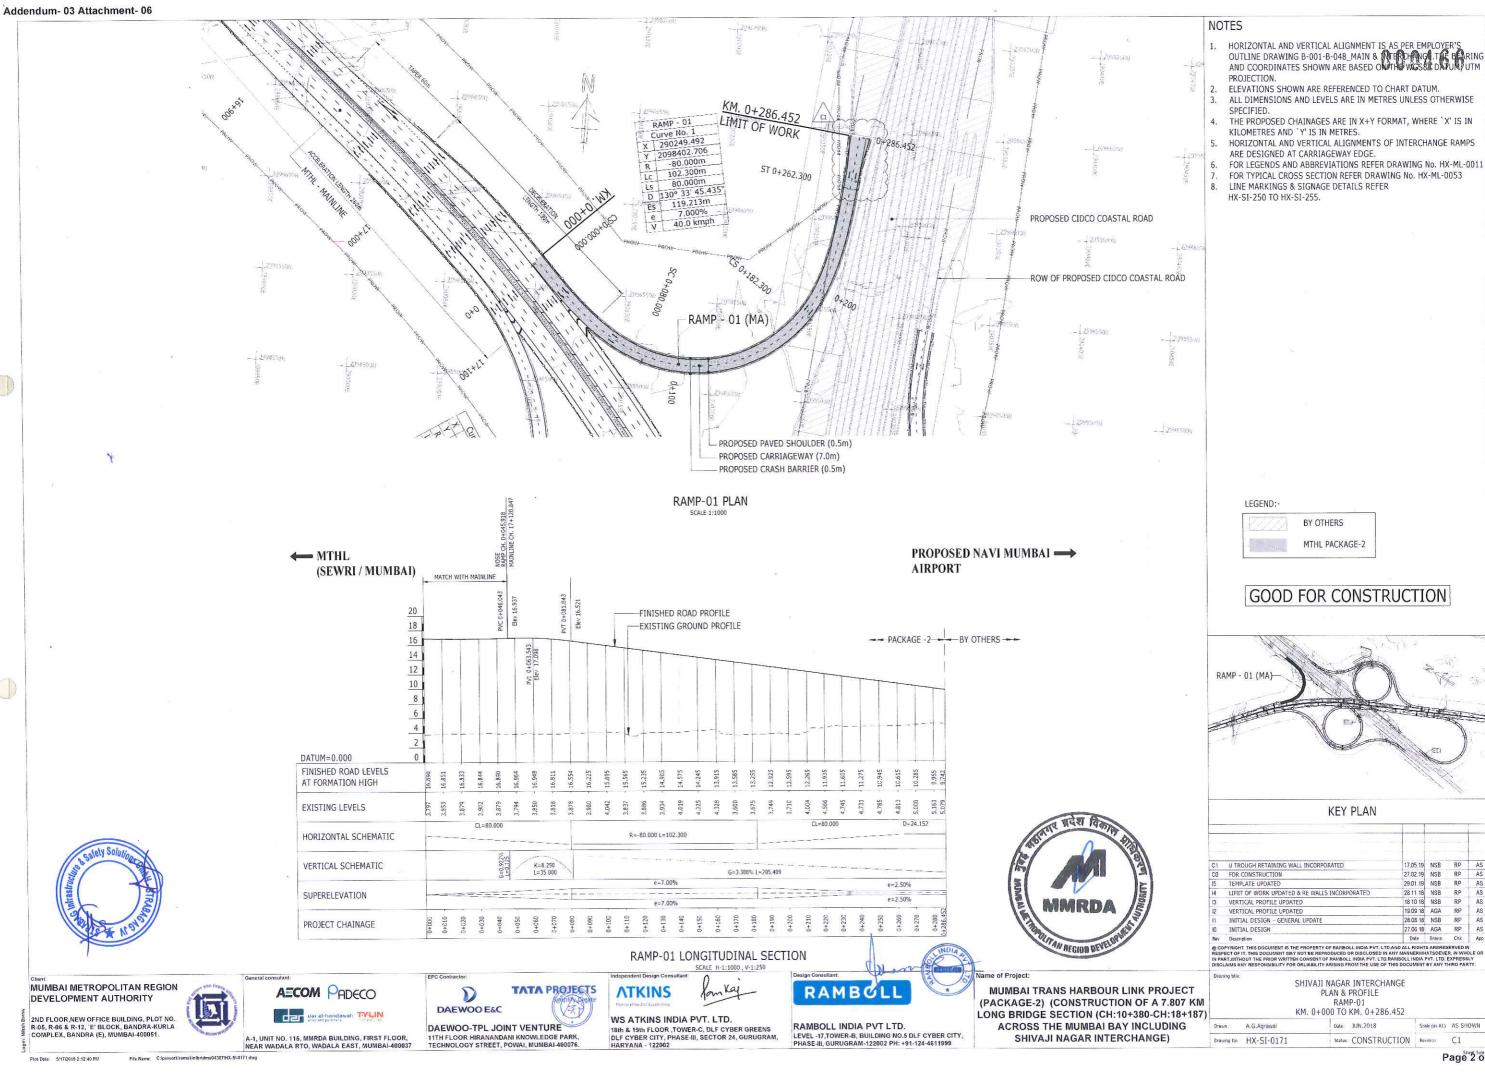(



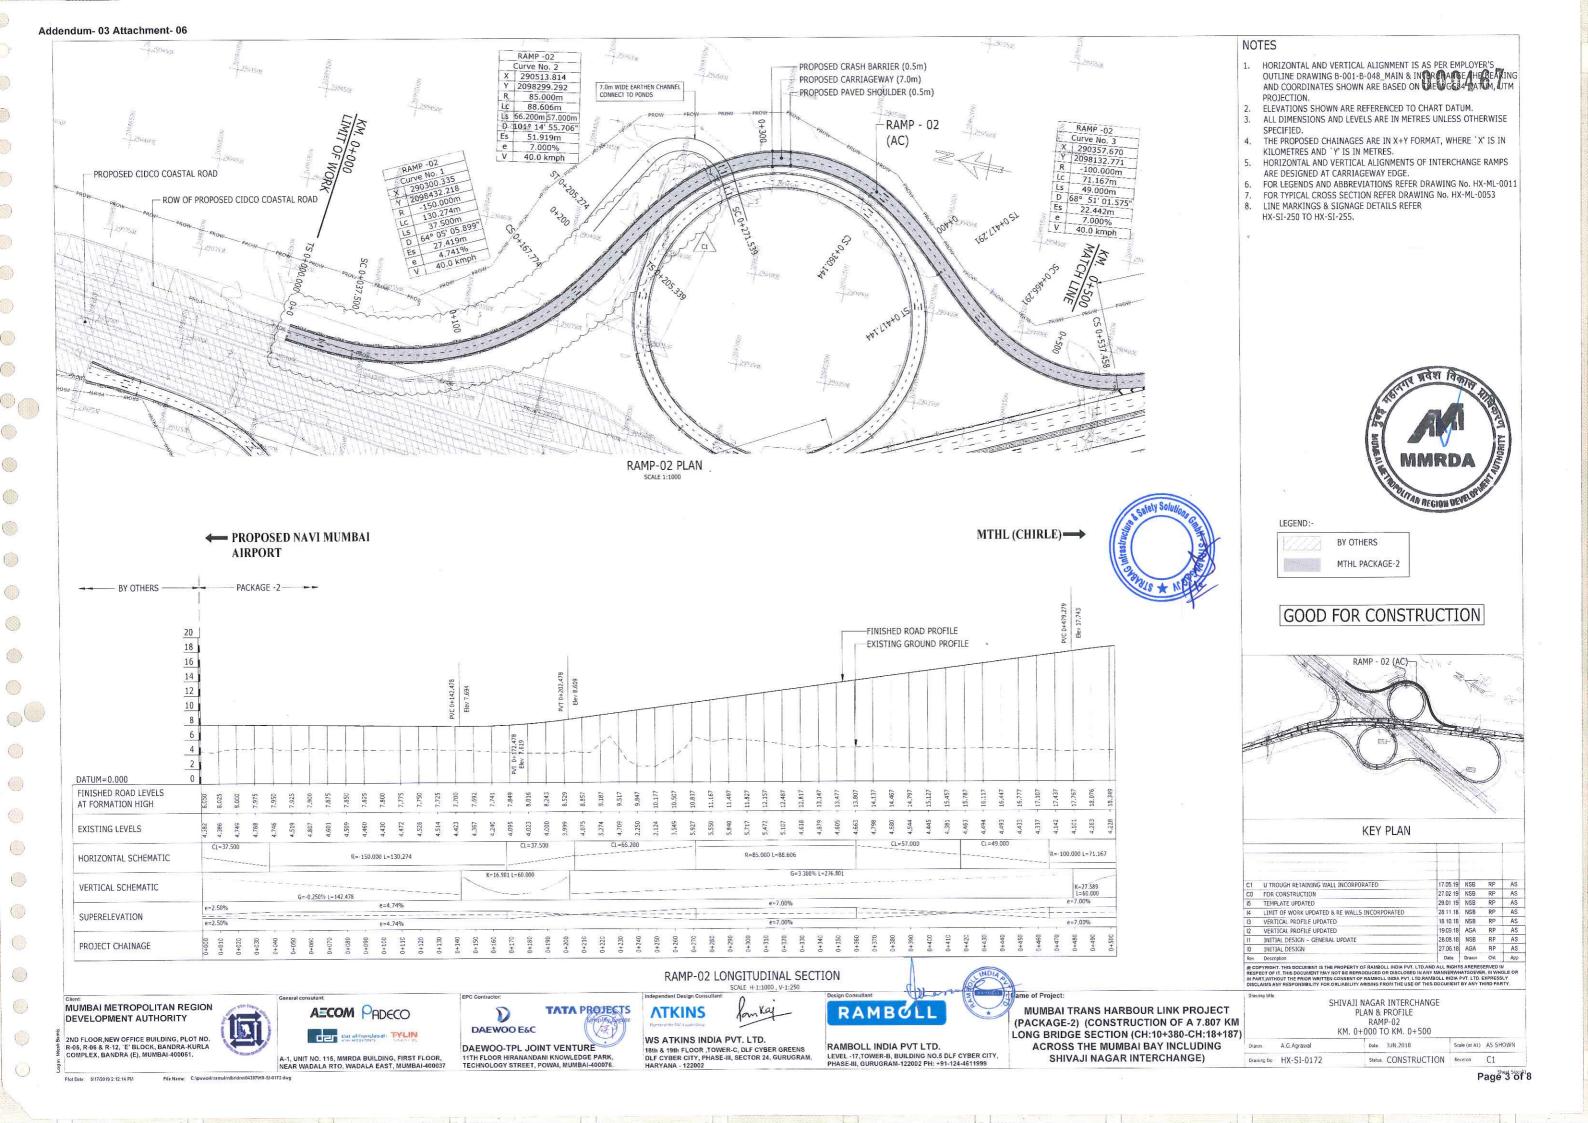

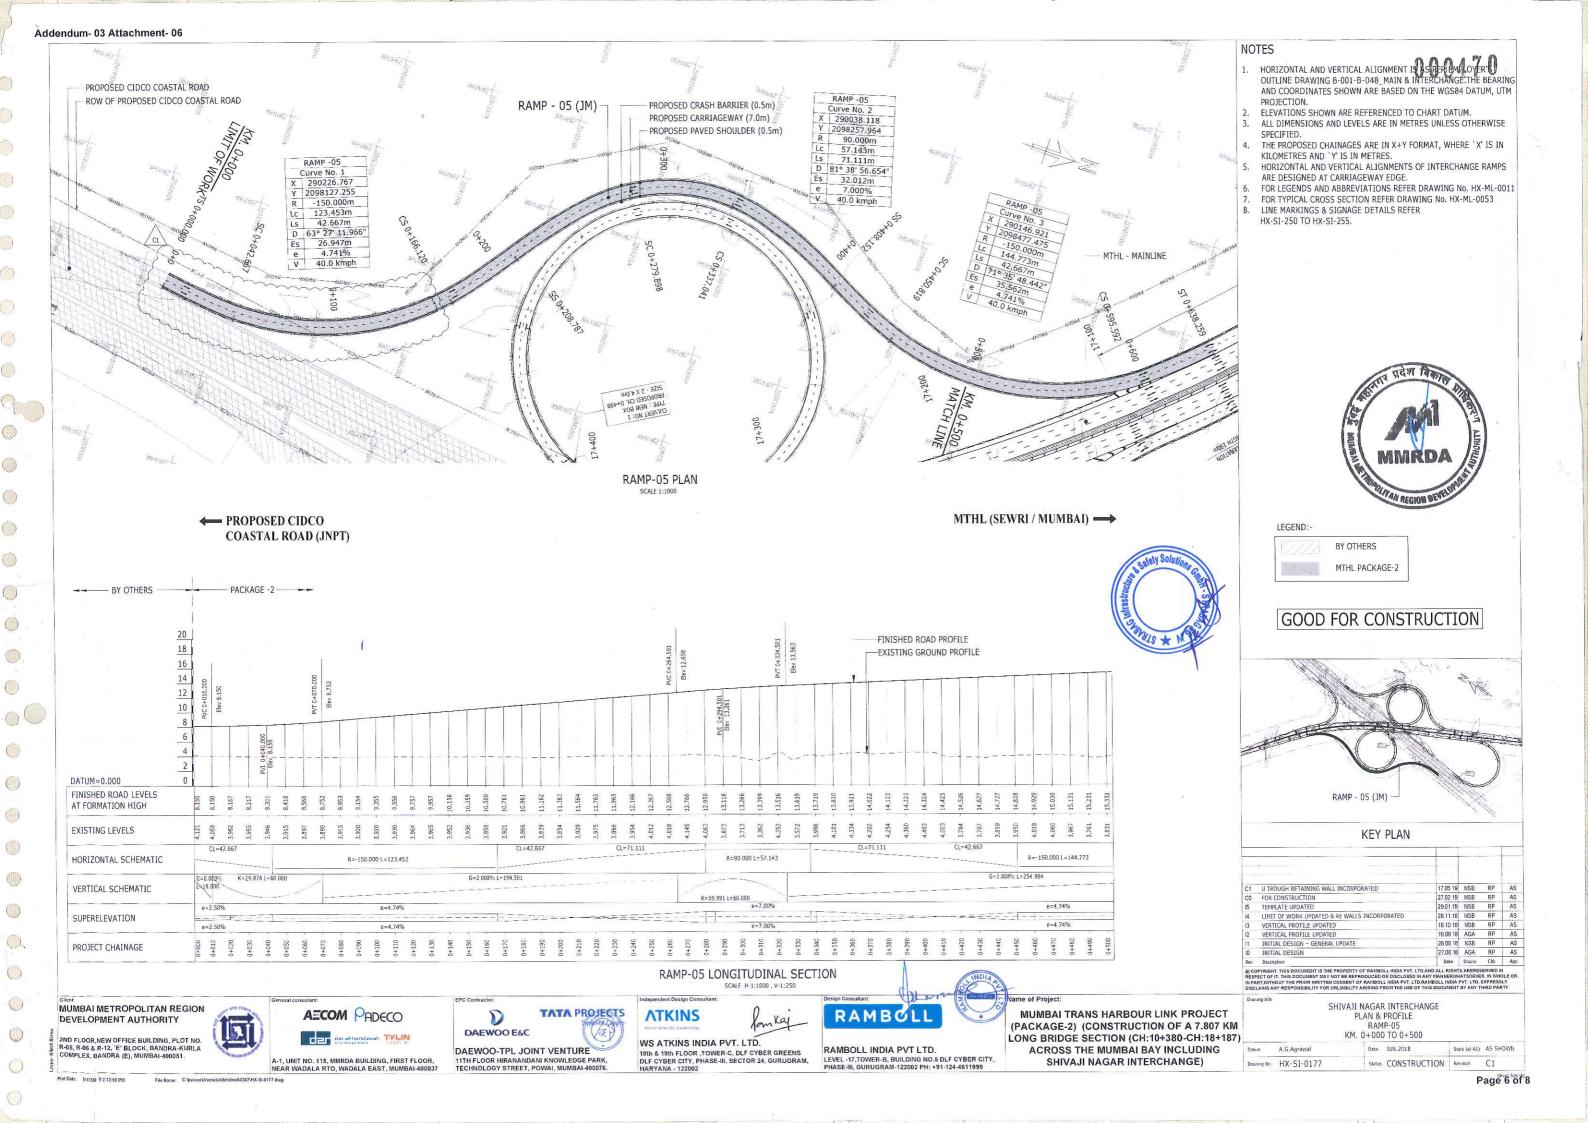

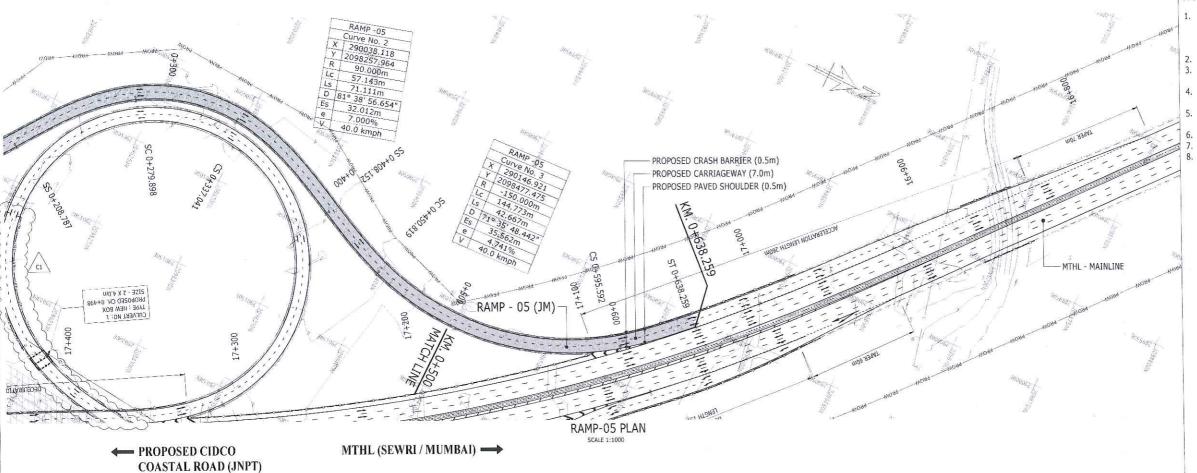

MATCH WITH MAINLINE -FINISHED ROAD PROFILE EXISTING GROUND PROFILE 18 16 12 10 DATUM=0.000 FINISHED ROAD LEVELS AT FORMATION HIGH 3.851 3.861 3.854 3.854 3.864 3.914 3.867 EXISTING LEVELS HORIZONTAL SCHEMATIC R=-150,000 L=144.773 VERTICAL SCHEMATIC L=254.984

RAMP-05 LONGITUDINAL SECTION

MUMBAI METROPOLITAN REGION DEVELOPMENT AUTHORITY

2ND FLOOR,NEW OFFICE BUILDING, PLOT NO. R-05, R-06 & R-12, "E" BLOCK, BANDRA-KURLA COMPLEX, BANDRA (E), MUMBAI-400051.



AECOM PADECO der al-frantiesels TYLIN

A-1, UNIT NO. 115, MMRDA BUILDING, FIRST FLOOR, NEAR WADALA RTO, WADALA EAST, MUMBAI-400037

AS PER MAINLINE

TATA PROJECTS D DAEWOO E&C DAEWOO-TPL JOINT VENTURE

ATKINS 11TH FLOOR HIRANANDANI KNOWLEDGE PARK, TECHNOLOGY STREET, POWAI, MUMBAI-400076.

WS ATKINS INDIA PVT. LTD. 18th & 19th FLOOR ,TOWER-C, DLF CYBER GREENS DLF CYBER CITY, PHASE-III, SECTOR 24, GURUGRAM,

RAMBOLL

RAMBOLL INDIA PVT LTD.


MUMBAI TRANS HARBOUR LINK PROJECT (PACKAGE-2) (CONSTRUCTION OF A 7.807 KM LONG BRIDGE SECTION (CH:10+380-CH:18+187) ACROSS THE MUMBAI BAY INCLUDING SHIVAJI NAGAR INTERCHANGE)

NOTES


- HORIZONTAL AND VERTICAL ALIGNMENT SEET EMPLOYER'S
 OUTLINE DRAWING B-001-B-048_MAIN & INTERCHANGE. THE BEARING AND COORDINATES SHOWN ARE BASED ON THE WGS84 DATUM, UTM
- ELEVATIONS SHOWN ARE REFERENCED TO CHART DATUM.
- ALL DIMENSIONS AND LEVELS ARE IN METRES UNLESS OTHERWISE SPECIFIED. THE PROPOSED CHAINAGES ARE IN X+Y FORMAT, WHERE 'X' IS IN
- KILOMETRES AND 'Y' IS IN METRES. HORIZONTAL AND VERTICAL ALIGNMENTS OF INTERCHANGE RAMPS
- ARE DESIGNED AT CARRIAGEWAY EDGE.
 FOR LEGENDS AND ABBREVIATIONS REFER DRAWING No. HX-ML-0011
 FOR TYPICAL CROSS SECTION REFER DRAWING No. HX-ML-0053
 LINE MARKINGS & SIGNAGE DETAILS REFER

- HX-SI-250 TO HX-SI-255.

LEGEND:-

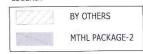

GOOD FOR CONSTRUCTION

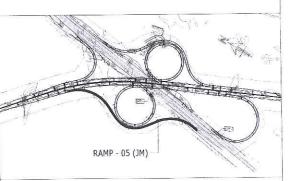

KEY PLAN

C1	U TROUGH RETAINING WALL INCORPORATED	17.05.19	NSB	RP	AS
CO	FOR CONSTRUCTION	27 02 19	NSB	RP	AS
15	TEMPLATE UPDATED	29.01 19	NSB	RP	AS
14	LIMIT OF WORK UPDATED & RE WALLS INCORPORATED	28.11.18	NSB	RP	AS
13	VERTICAL PROFILE UPDATED	18 10 18	NSB	RP	AS
12	VERTICAL PROFILE UPDATED	19 09 18	AGA	RP	AS
11	INITIAL DESIGN - GENERAL UPDATE	28.08.18	NSB	RP	AS
10	INITIAL DESIGN	27.06.18	AGA	RP	AS
Rev	Description	Date	Drawn	Chk	App

SHIVAJI NAGAR INTERCHANGE PLAN & PROFILE RAMP-05

KM, 0+500 TO KM, 0+638,259 Scale (at A1). AS SHOWN A.G.Agrawal Date JUN.2018 Drawing No HX-SI-0178

Status CONSTRUCTION Revision C1

SUPERELEVATION

PROJECT CHAINAGE

